NEW YORK CITY ECONOMIC DEVELOPMENT CORPORATION



BELLA ABZUG PARK BLOCK 5 & 6 DEMOLITION BLOCK 709, LOT 52

533-541 W. 38TH STREET NEW YORK, NY

90% SUBMISSION


XXXX, XX, 2023

LIST OF	- ABBREVIATIONS				
A.DR.	ACCESS DOOR	G.R.	GUARD RAIL	Q.T.	QUARRY TILE
A.F.F.	ABOVE FINISHED FLOOR	GA.	GALVANIZED		
A.P. ABV.	ACCESS PANEL ABOVE	GALV. GL.	GALVANIZED GLASS	R.D.	ROOF DRAIN
AC.T.	ACOUSTIC TILE	GR.	GRILL	RAD.	RADIUS
ADJ.	ADJUSTABLE OR ADJACENT	GRTG.	GRATING	REF. REINF.	REFERENCE REINFORCED:ING:MENT
ALUM.	ALUMINUM	GTC	GROUND TRANSPORTATION CENTER	REQ.	REQUIRED
ANG.	ANGLE			RM.	ROOM
ANOD.	ANODIZED	H.	HIGH	RW	RAIN WATER
APPD.	APPROVED APPROXIMATE	H.M.	HOLLOW METAL		
APPROX. ARCH.	ARCHITECTURAL	H.P. H.R.	HIGH POINT	SAF.	SAFETY
ASTM	AMERICAN SOCIETY FOR	п.к. H.S.	HANDRAIL HIGH STRENGTH	S.D. S.F.	SOAP DISPENSER
	TESTING AND MATERIALS	H.V.A.C.	HEATING, VENTILATION &	S.F. S.P.	SQUARE FEET SEE PLAN
	INTERNATIONAL		AIR CONDITIONING	S.PT.	STARTING POINT
		HD.	HEAD	S.S.	STAINLESS STEEL
В.	BASE	HDR. HEX.	HEADER HEXAGONAL	SDL.	SADDLE
B.L. BD.	BUILDING LINE BOARD	HGT.	HEIGHT	SECT. SHT.	SECTION SHEET
BKT.	BRACKET	HORIZ.	HORIZONTAL	SIM.	SIMILAR
BLDG.	BUILDING			5 .	
BM.	BEAM	I.D.	INSIDE DIAMETER		
BOT.	BOTTOM	INCL.	INCLUDING	SLD'G.	SLIDING
BRK.	BRICK	INFO.	INFORMATION	SPEC.	SPECIFICATION
		INSUL.	INSULATION	SQ. ST.	SQUARE STAINLESS
C.	COURSES	INT.	INTERIOR	STIFF.	STIFFENER
C.H.	CEILING HEIGHT			STL.	STEEL
C.JT. C.L.	CONSTRUCTION JOINT CENTERLINE	JT.	JOINT	STRUCT.	STRUCTURAL
C.L. C.M.U.	CONCRETE MASONRY UNIT			SUSP.	SUSPENDED
C.R.	CEILING REGISTER		KIDO	SYS.	SYSTEM
C.S.	CONCRETE SLAB	K.	KIPS		
CAB.	CABINET			_	
CEM.	CEMENT	L.	ANGLE	T.	TREAD
CER.T. CHAN.	CERAMIC TILE CHANNEL	L.L.	LIVE LOAD	T.&B. T.&G.	TOP AND BOTTOM TONGUE AND GROOVE
CLG.	CEILING	L.P.	LOW POINT	T.&S.	TAPE AND SPACKLE
COL.	COLUMN	L.W.	LIGHT WEIGHT	T.O.	TOP OF
CONC.	CONCRETE	LAM.	LAMINATED	T.O.MAS.	TOP OF MASONRY
COND.	CONDITIONS	LAV. LG.	LAVATORY LONG	T.O.SL.	TOP OF SLAB
CONN.	CONNECTION	LT.	LIGHT	T.O.S.	TOP OF STEEL
CONST. CONT.	CONSTRUCTION CONTINUOUS	LTG.	LIGHTING	TAN. TEMP.	TANGENT TEMPORARY
CONV.	CONVECTOR			TERM.	TERMINAL
CORR.	CORRUGATED			THK.	THICK
CSK.	COUNTERSINK:SUNK			TRANSF.	TRANSFORMER
CT	CERAMIC TILE	M.D.	METAL DECK	TYP.	TYPICAL
CTA	CENTRAL TERMINAL AREA	M.H.	MANHOLE		
D.	DIAMETER	M.O.	MASONRY OPENING	550	LINDEDWOITERS LARGRATORY RESIGNA
D.O.	DITTO	MANUF.	MANUFACTURER	U.L.DES. U.N.	UNDERWRITERS LABORATORY DESIGN UNLESS NOTED
DBL.	DOUBLE	MAS. MAT'L.	MASONRY MATERIAL	UNIF.	UNIFORM
DEPT.	DEPARTMENT	MAX.	MAXIMUM	UNFIN.	UNFINISHED
DESCR.	DESCRIPTION	MECH.	MECHANICAL		
DET. DIA.	DETAIL DIAMETER	MFG.	MANUFACTURER		
DIFF.	DIFFUSER	MIN.	MINIMUM	V.I.F.	VERIFY IN FIELD
DIM.	DIMENSION	MISC.	MISCELLANEOUS	VERT.	VERTICAL
DN.	DOWN	MTL.	METAL		
DR.	DOOR				
DWG.	DRAWING	N.	NORTH	W/	WITH
Ε.Δ.	FACIL	N.F.	NEAR FACE	W.	WIDE
EA. EL.	EACH ELEVATION	NO.	NUMBER	•••	
ELEC.	ELECTRICAL	N.S.	NEAR SIDE	W.P.	WORKING POINT
ELEV.	ELEVATOR	N.T.S.	NOT TO SCALE	W.R.	WASTE RECEPTACLE
EMERG	EMERGENCY CALL BOX	NY	NEW YORK		
ENCL.	ENCLOSURE				
EQ. EQ.SP.	EQUAL EQUAL SPACES	O.A.	OVER ALL		
EQUIP.	EQUIPMENT	O.C.	ON CENTER		
ETC.	ETCETRA	O.H.	OVER HEAD		
EXT.	EXTERIOR	OPN'G.	OPENING		
EXIST.	EXISTING	OPP.	OPPOSITE		
EXP.JT.	EXPANSION JOINT	O.D.	OUTSIDE DIAMETER		
EXPN. EXTN.	EXPANSION EXTENSION				
E.W.C.	ELECTRIC WATER COOLER				
		PART.	PARTITION		
		PENETR.	PENETRATION		
F.A.	FRESH AIR	P.I.P.	POURED IN PLACE		
F.D. F.FLR	FLOOR DRAIN FINISH FLOOR	PL.	PLATE DI ASTER		
F.FLR F.O.	FACE OF	PLAS. PLUMB.	PLASTER PLUMBING		
F.P.	FIRE PROOFING	P.M.	PREMOLDED		
FDN.	FOUNDATION	PNL.	PANEL		
FIN. FIXT.	FINISHED FIXTURE	POL.	POLISHED		
FIX I.	FLUSH	PREFAB.	PREFABRICATED		
FLR.	FLOOR	P.S.F.	POUNDS PER SQUARE FOOT		
FLT.HD.	FLAT HEAD	P.S.I. PT.	POUNDS PER SQUARE INCH PART		
FR.	FRAME	PTD.	PAINTED		
FT.	FEET:FOOT				
FTG. FUT.	FOOTING FUTURE				

SHEET# —

ELEVATION INDICATOR

MATCH LINE ---

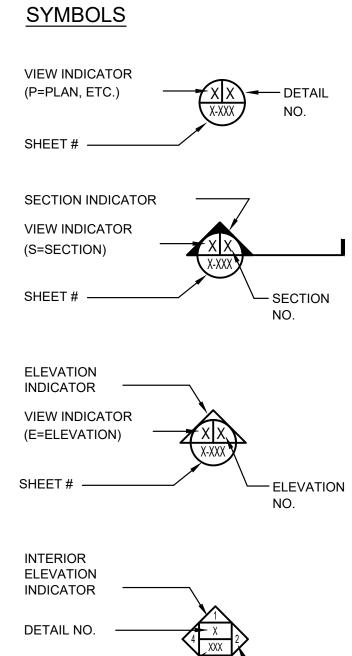

— ELEVATION

DRAWING INDEX

SHEET NO.	DRAWING NO.	DRAWING TITLE
1	G-000	COVER SHEET
2	G-001	ABBREVIATIONS, SYMBOLS AND DRAWING INDEX
3	G-002	GENERAL DEMOLITION NOTES
4	G-003	SITE PLAN
5	DM-100	CELLAR FLOOR DEMOLITION PLAN
6	DM-101	1ST FLOOR &TYPICAL 2ND-5TH FLOOR DEMO. PLANS
7	DM-102	TYPICAL 6TH-8TH & 9TH-10TH FLOOR DEMO. PLANS
8	DM-103	11TH FLOOR & ROOF LEVEL DEMO. PLANS
9	DM-104	ELECTRICAL PLATFORMS & WATER TOWER DEMO. PLANS
10	DM-201	NORTH & SOUTH DEMOLITION EXTERIOR ELEVATIONS
11	DM-202	EAST & WEST DEMOLITION EXTERIOR ELEVATION
12	DM-301	STRUCTURAL DEMOLITION SECTIONS
13	DM-302	STRUCTURAL DEMOLITION SECTIONS

BELLA ABZUG PARK BLOCKS 5 & 6

CLIENT GROUP







WARNING: IT IS A VIOLATION OF NEW YORK LAW FOR ANY PERSON, UNLESS ACTING UNDER THE DIRECTION OF A LICENSED ARCHITECT, LANDSCAPE ARCHITECT, PROFESSIONAL ENGINEER, OR LAND SURVEYOR (AS APPLICABLE) TO ALTER ANY ITEM SHOWN ON THIS DOCUMENT IN ANY WAY. IF A DOCUMENT OR ITEM BEARING THE SEAL OF ANY SUCH LICENSED PROFESSIONAL IS ALTERED, THE ALTERING ARCHITECT, LANDSCAPE ARCHITECT, PROFESSIONAL ENGINEER, OR LAND SURVEYOR SHALL AFFIX TO EACH ALTERED ITEM THEIR SEAL WITH THE NOTATION "ALTERED BY" FOLLOWED BY THEIR SIGNATURE WITH THE DATE AND A SPECIFIC DESCRIPTION OF EACH ALTERATION.

NOT FOR CONSTRUCTION

STATUS

REVISIONS

NO. DATE DESCRIPTION

DRAWING TITLE


ABBREVIATIONS, SYMBOLS AND DRAWINGS INDEX

DRAWING NUMBER

G-001

SCALE

04/03/2020 1/8" = 1'-0" DRAWN BY D.SYROM CHECKED BY

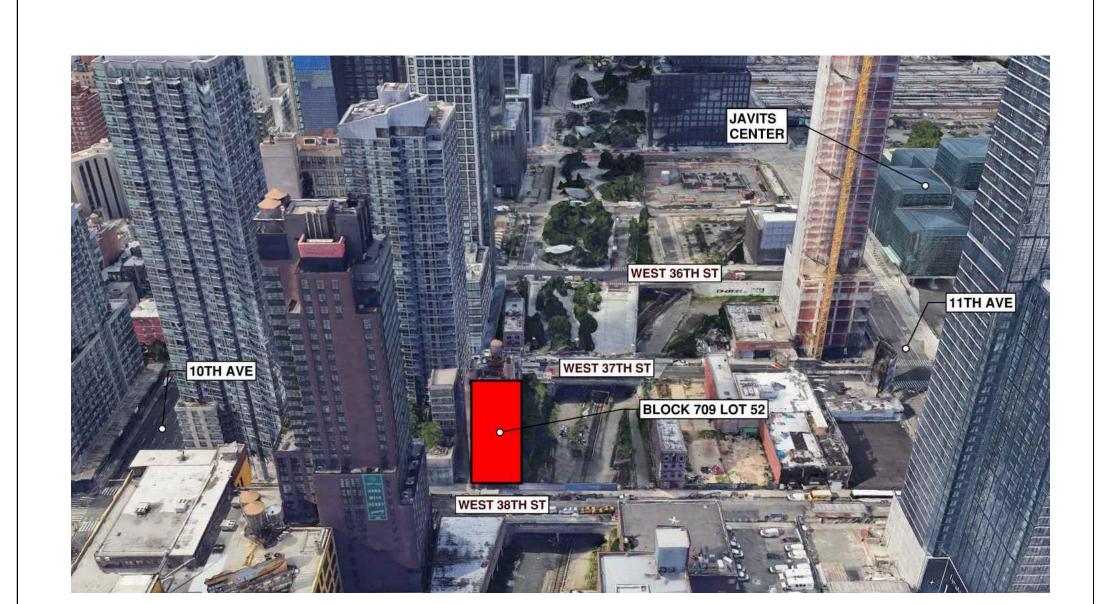



GENERAL NOTES:

CONSTRUCTION.

- 1. INFORMATION PROVIDED BY CONTRACT DRAWINGS MAY NOT MATCH ACTUAL FIELD CONDITIONS. VERIFY ALL INDICATED CONDITIONS AND DIMENSIONS IN THE FIELD BEFORE COMMENCING ANY WORK. NOTIFY THE ENGINEER OF ANY CONDITIONS OR DIMENSIONS THAT WOULD PREVENT OR HAMPER THE PERFORMANCE OF THE WORK IN ACCORDANCE WITH THE CONTRACT DRAWINGS AND SPECIFICATIONS. SEE DIVISION 1 OF THE CONTRACT BOOK.
- 2. EACH BIDDER SHALL INSPECT THE SITE AND CAREFULLY EXAMINE AND ANALYZE THE PROVISIONS AND REQUIREMENTS OF THE CONTRACT AND UNDERSTAND ALL THINGS REQUIRED FOR THE PERFORMANCE OF THIS CONTRACT. FOR BELOW GRADE STRUCTURAL ELEMENTS SUCH AS FLOOR SLAB, GRADE BEAMS, PILE CAPS, PILES, PITS, TRENCHES, ETC., REFER TO STRUCTURAL CONTRACT DRAWINGS
- 3. UNLESS OTHERWISE NOTED ON CONTRACT DRAWINGS, REMOVE AND DISPOSE OF THE ENTIRE BUILDING INCLUDING, BUT NOT LIMITED TO STRUCTURES, FOUNDATIONS, UNDERGROUND PITS AND TRENCHES, ELECTRICAL, PLUMBING & MECHANICAL EQUIPMENT, FINISHES AND ANY OTHER CONTENT WITHIN THE PERIMETER FENCE. REFER TO CONTRACT SPECIFICATION SECTION 02050 "DEMOLITION AND DISPOSAL" FOR ADDITIONAL DEMOLITION DESIGN AND PERFORMANCE, DEMOLITION, PROTECTION, AND POLLUTION CONTROL REQUIREMENTS.
- 4. UNLESS OTHERWISE NOTED ON CONTRACT DRAWINGS, CLEAR ALL OBSTRUCTIONS PROTRUDING FROM EXISTING GRADE INCLUDING, BUT NOT LIMITED TO SIDEWALK, CURBS, GUARDRAILS, TRAFFIC SIGNS, CONCRETE PADS, EXTERIOR STAIRCASES, PLATFORMS, RAILINGS AND THEIR ASSOCIATED FOUNDATION.
- 5. FREE ACCESS TO FIRE HYDRANTS AND TO OUTSIDE CONNECTIONS FOR STANDPIPES, SPRINKLERS, OR OTHER FIRE EXTINGUISHING EQUIPMENT, WHETHER PERMANENT OR TEMPORARY SHALL BE PROVIDED AND MAINTAINED AT ALL TIMES
- 6. NO MATERIAL, EQUIPMENT OR CONSTRUCTION SHALL INTERFERE WITH ACCESS TO HYDRANTS, SIAMESE CONNECTIONS OR FIRE EXTINGUISHING EQUIPMENT.
- 7. FOR RECYCLING OF DESIGNATED DEBRIS MATERIAL, SEE SPECIFICATION
- 8. STOCKPILES OF DEBRIS AND SOIL SHALL BE SECURED AND LOCATED WITHIN PERIMETER FENCE. STOCKPILES SHALL BE NO HIGHER THAN EIGHT FEET IN HEIGHT. SEE CIVIL DRAWINGS FOR PERIMETER FENCE LOCATION. SPRAY WATER TO WET DOWN STOCKPILES FOR DUST CONTROL. MATERIALS CAPABLE OF CREATING FOREIGN OBJECT DEBRIS MUST BE CONTINUOUSLY REMOVED DURING
- 9. STOCKPILES OF DEBRIS FOR EXISTING FOUNDATION ELEMENTS, INCLUDING REINFORCED CONCRETE, GROUND FLOOR SLABS, UNDERGROUND PILE CAPS, PILES, UNDERGROUND GRADE BEAMS, UNDERGROUND TRENCHES AND UNDERGROUND PITS SHALL BE CLEARLY SEPARATED FROM OTHER CONSTRUCTION DEBRIS STOCKPILES. MATERIALS SHOULD BE TESTED FOR CONTAMINATION AND IF POSITIVE, DISPOSED OF AS REQUIRED BY LOCAL JURISDICTIONS
- 10. PROVIDE ONE TRAINED SITE SECURITY GUARD AT THE CONSTRUCTION ACCESS GATE IN ACCORDANCE WITH NFPA 241 SITE SECURITY GUARD REQUIREMENTS. THE GUARD(S) SHALL BE ON DUTY DURING ALL HOURS, BOTH WHEN OPERATIONS ARE IN PROGRESS AND WHEN OPERATIONS ARE NOT IN PROGRESS.
- 11. ASSIGN WATCHPERSON AND FLAGPERSON IN ACCORDANCE WITH NYCBC 3307.5 REQUIREMENTS.
- 12. PEDESTRIANS SHALL BE PROTECTED DURING ALL CONSTRUCTION AND DEMOLITION ACTIVITIES. FURNISH, INSTALL AND MAINTAIN FENCE AND SIDEWALK SHED (IF REQUIRED) ALONG SIDEWALK DURING DEMOLITION IN ACCORDANCE WITH NYC BUILDING CODE. DESIGN FENCE, SIDEWALK SHED AND ITS LIGHTING SYSTEM ACCORDING TO NYC BUILDING CODE BY PROFESSIONAL ENGINEERS LICENSED IN NEW YORK. CLOSE SIDEWALK TEMPORARILY AS REQUIRED FOR EXTERIOR BUILDING DEMOLITION WORK WHERE PEDESTRIANS COULD NOT BE PROTECTED SUCH AS AT AREA NEAR CONSTRUCTION ENTRANCE GATE. SIDEWALK SHED LIGHTS SHOULD BE POWERED FROM CONTRACTORS TEMPORARY POWER. SIDEWALK SHED AREA NEAR CONSTRUCTION ENTRANCE GATE. SIDEWALK SHED LIGHTS SHOULD BE POWERED FROM CONTRACTORS TEMPORARY POWER. SIDEWALK SHED SHALL NOT BE CONSTRUCTED SO THAT IT IMPEDES ACCESS TO HYDRANTS.
- 13. TAKE ALL NECESSARY PRECAUTIONS TO PROTECT ALL EXISTING UTILITIES THAT ARE TO REMAIN. ANY UTILITIES DAMAGED BY THE CONTRACTOR SHALL BE REPAIRED OR REPLACED IMMEDIATELY AT NO ADDITIONAL COST, DESIGNED BY NY STATE LICENSED PROFESSIONAL ENGINEER. ALL DEMOLITION SHALL BE ON HOLD UNTIL THE REPAIR OR REPLACEMENT WORKS HAVE BEEN COMPLETED, AND TO THE SATISFACTION OF THE ENGINEER. CUTTING AND CAPPING OF UTILITIES WILL BE BY OTHERS.
- 14. TAKE ALL NECESSARY PRECAUTIONS TO ENSURE NO DEBRIS OR FOREIGN OBJECT DEBRIS PROJECT BEYOND THE SAFE WORK ZONE PERIMETER ESTABLISHED BY THE CONTRACTOR. AT ALL TIMES FURNISH AND INSTALL TEMPORARY SOLID FENCING, OTHER THAN PERIMETER FENCE, TO CONTAIN DEBRIS OR FOREIGN OBJECT DEBRIS THAT COULD BE PROJECTED AND/OR BE CARRIED BY WIND INTO ADJACENT AREAS.
- 15. REFER TO SPECIFICATIONS FOR REQUIREMENTS OF ALL TEMPORARY PROTECTIONS AND SHORING DESIGN DRAWINGS AND CALCULATIONS.
- 16. THE LOCATION, ELEVATION AND SIZE OF EXISTING UTILITIES SHOWN ON THE CONTRACT DRAWINGS ARE APPROXIMATE. THE FOLLOWING SHALL BE
- A. VERIFY THE LOCATION OF EXISTING UNDERGROUND UTILITIES WITHIN THE WORK AREA PRIOR TO
- B. EXERCISE EXTREME CAUTION, INCLUDING HAND EXCAVATION, TO EXPOSE LINES WHEN WORK IS ADJACENT TO EXISTING POWER, COMMUNICATIONS, WATER AND GAS LINES TO PREVENT DAMAGE TO THESE LINES.
- C. IMMEDIATELY REPAIR ANY DAMAGE TO EXISTING UTILITIES CAUSED BY THE CONTRACTOR IN A MANNER
- APPROVED BY THE ENGINEER, AT NO ADDITIONAL COST TO THE AUTHORITY.
- 17. ALLOW TIME FOR THE CM TO PERFORM FIELD SURVEY ON THE LOCATION OF ALL EXISTING PILES, USING CENTER POINT AT TOP OF EACH PILE AS REFERENCE POINT, PRIOR TO SOIL BACKFILL. REFER TO SPECIFICATIONS FOR SUBMTTAL REQUIREMENTS.
- 18. PREVENT WATER PONDING FROM CONTRACTOR'S OPERATIONS. PROMPTLY REMOVE ANY PONDING WATER TO THE SATISFACTION OF THE ENGINEER.
- 19. IT IS ASSUMED THAT ALL STRUCTURAL STEEL IS COATED WITH LEAD CONTAINING PAINT. LEAD CONTAINING PAINT MUST BE REMOVED 4 INCHES ON EACH SIDE OF THE CENTERLINE OF CUT, BOLT ROW, OR WELD FROM STRUCTURAL STEEL PRIOR TO ANY HEATING, WELDING, FLAME CUTTING, OR SAW CUTTING. REFER TO SPECIFICATIONS FOR PROPER ABATEMENT PROCEDURES.
- 20. CONTRACTOR SHOULD CONFORM TO THE FOLLOWING CODES. STANDARDS, AND SPECIAL INSPECTIONS THROUGHOUT THE DEMOLITION: 2014 NYC BUILDING CODE, 2014 NYC FIRE CODE, AND NYC BUILDING CODE BC 1704.20.
- 21. MAINTAIN SECURITY FENCING AT ALL TIMES.
- 22. ALL EROSION AND SEDIMENT CONTROL DEVICES SHALL BE COMPLETED PRIOR TO COMMENCEMENT OF DEMOLITION.
- 23. HORIZONTAL CONTROL POINTS: ALL BEARINGS AND COORDINATES ARE BASED ON NORTH AMERICAN DATUM OF 1983 (NAD83/2007) AND NEW YORK STATE PLANE COORDINATE SYSTEM LONG ISLAND (NYSPES LI).
- 24. VERTICAL CONTROL POINTS: ALL VERTICAL ELEVATIONS AND CONTOURS ARE IN FEET AND REFER TO THE NORTH AMERICAN VERTICAL DATUM OF 1988 (NAVD88).

STRUCTURAL NOTES:

- 1. VERIFY ALL DIMENSIONS AND CONDITIONS OF EXISTING STRUCTURES CONTROLLING NEW CONSTRUCTION IN THE FIELD. PREPARE SHOP DRAWINGS BASED ON THE ACTUAL FIELD CONDITIONS.
- 2. ANY PORTION OF EXISTING WORK WHICH IS TO REMAIN THAT IS DISTURBED OR DAMAGED IN THE COURSE OF DEMOLITION SHALL BE RESTORED TO A CONDITION AS GOOD AS THAT EXISTING BEFORE THE COMMENCEMENT OF THE WORK.
- 3. ELEVATIONS INDICATED ON ALL DEMOLITION DRAWINGS BASED ON NAVD88. ELEVATIONS SHOWN ON ALL REFERENCE DRAWINGS BASED ON NGVD29. TO CONVERT THE REFERENCE DRAWING ELEVATIONS FROM NGVD29 TO NAVD88, SUBTRACT 3.2 FEET FROM THE REFERENCE DRAWING ELEVATIONS.
- 4. MAINTAIN AND PROTECT EXISTING UTILITIES THAT MUST REMAIN IN SERVICE AND EQUIPMENT. NOTIFY THE ENGINEER 48 HOURS IN ADVANCE OF ANY WORK ON OR IN THE VICINITY OF ANY DUCT LINES. USE HAND EXCAVATION TO DETERMINE THE EXACT LOCATION OF ALL UTILITIES. INSULATE ALL CONSTRUCTION EQUIPMENT TO AVOID ACCIDENTAL GROUNDING.
- 5. REFER TO SPECIFICATIONS FOR SUBMITTAL REQUIREMENTS FOR ALL TEMPORARY CONSTRUCTION STRUCTURES USED FOR SHORING, BRACING AND
- 6. QUALIFIED PERSONNEL, AS DEFINED IN NYCBC SECTION 3302, SHALL BE USED FOR REMOVAL AND DEMOLITION OPERATIONS. REMOVAL AND DEMOLITION OPERATIONS SHALL BE PERFORMED IN A CAREFUL AND CONTROLLED MANNER TO AVOID HAZARDS TO PERSONS, DAMAGE TO PROPERTY AND ANY SPREADING OF DUST AND FLYING PARTICLES.
- 7. NO PORTIONS OF THE REMOVAL SHALL BE PERMITTED TO FALL NOR SHALL ANY DEBRIS BE DROPPED. PROPER METHODS SHALL BE USED TO ENSURE LIFE SAFETY AND INTEGRITY OF THE EXISTING STRUCTURE.
- 8. ASBESTOS ABATEMENT AND HAZARDOUS MATERIALS REMEDIATION SHALL BE COMPLETED PRIOR TO COMMENCEMENT OF STRUCTURAL DEMOLITION.

MECHANICAL NOTES:

HVAC DEMOLITION NOTES

- 1. PRIOR TO REMOVAL OF MECHANICAL EQUIPMENT, DISCONNECT PIPING AND ENSURE ELECTRICAL POWER SUPPLY HAS BEEN DISCONNECTED.
- 2. PRIOR TO REMOVAL OF ALL WATER AND OIL PIPING, DRAIN THE PIPING AND DISPOSE WATER AND OIL IN ACCORDANCE WITH APPLICABLE ENVIRONMENTAL REGULATIONS.
- 3. REMOVE AND RECOVER ALL REFRIGERANTS FROM ALL REFRIGERATION EQUIPMENT AND PIPING PRIOR TO COMMENCING ANY EQUIPMENT AND/OR BUILDING DEMOLITION. DISCONNECT AND REMOVE ALL REFRIGERATION EQUIPMENT INCLUDING PIPING, ELECTRICAL POWER SUPPLY AND AUXILIARY EQUIPMENT PRIOR TO BUILDING DEMOLITION.
- 4. REMOVE ALL HVAC EQUIPMENT INCLUDING, BUT NOT LIMITED TO, SUPPLY AIR FANS, VENTILATING UNITS, FANS, DUCTWORK, FLUES, PUMPS, PIPING, ELECTRICAL POWER SUPPLY AND CONTROLS PRIOR TO BUILDING DEMOLITION.

ELEVATOR DEMOLITION NOTES:

- 1. ELEVATOR SHALL BE POSITIONED AT THE LOWEST LEVEL PRIOR TO ELECTRICITY SHUT DOWN.
- 2. DISCONNECT, DISMANTLE AND REMOVE THE ELEVATOR CAB AND ELECTRICAL AND HYDRAULIC EQUIPMENT AND APPURTENANCES, INCLUDING PIPING, ELECTRICAL POWER SUPPLY, TANK, MOTORS, CONTROLS, SUPPORTS, ETC.
- 3. PRIOR TO HYDRAULIC FLUID REMOVAL, DRAIN THE PIPING AND DISPOSE HYDRAULIC FLUID IN ACCORDANCE WITH APPLICABLE ENVIRONMENTAL REGULATIONS.
- 4. ELEVATORS BEING PERMANENTLY REMOVED FROM SERVICE (DISMANTLED) SHALL FOLLOW APPLICABLE ASME CODE A17.1-2000 WITH SUPPLEMENTS A17.1a-2002, AND A17.b-2003, AND NYC BUILDING CODE (INCLUDING APPENDIX K-SECTION 8.11.1.4, ELEVATORS PLACED OUT OF SERVICE (DISMANTLED). AN

FIRE PROTECTION DEMOLITION NOTES:

 DETERMINE MEANS AND METHODS FOR FULL DEMOLITION OF ALL PLUMBING AND FIRE PROTECTION SYSTEMS. COORDINATE PLUMBING AND FIRE PROTECTION DEMOLITION WORK WITH THE CONSTRUCTION PHASING PLAN SHOWN ON VOLUME 3 AND IN THE SPECIFICATIONS.

ELEVATOR INSPECTION WILL BE REQUIRED PER NYC BUILDING CODE 8.11.1.4.

- 2. PROVIDE THE ENGINEER 48 HOURS ADVANCE NOTICE OF THE INTENTION TO START FIELD WORK AT THE CONSTRUCTION SITE. WORK SHALL NOT BE STARTED UNTIL ALL NECESSARY EQUIPMENT AND MATERIALS ARE AT THE SITE.
- 3. PERFORM ALL CUTTING, DISASSEMBLY, TRANSPORTING, RIGGING, STAGING OF REMOVALS, REMOVAL AND DISPOSAL OF EXISTING EQUIPMENT, ASSOCIATED PIPING AND APPURTENANCES NECESSARY TO COMPLETE THE WORK OF THIS CONTRACT.
- 4. FIRE PROTECTION STANDPIPE SYSTEM: EXISTING STANDPIPE IS TO BE ENERGIZED AND FILLED PRIOR TO DEMOLITION START. ALL STANDPIPES ARE TO BE ACTIVE, WITH THE EXCEPTION OF WHEN THEY ARE BEING DEMOLISHED, THROUGHOUT THE DEMOLITION. STAND PIPES IN EXISTING STAIR TOWERS SHALL ALSO CONFORM TO THIS REQUIREMENT.

PLUMBING DEMOLITION NOTES

- PRIOR TO DISCONNECTING AND REMOVAL OF EXISTING PLUMBING FIXTURES AND PIPING, ENSURE THAT WATER SUPPLY HAS BEEN DISCONNECTED FROM THE MAIN WATER SERVICE.
- 2. READ AND RECORD EXISTING DOMESTIC WATER METER READING BEFORE REMOVING. SUBMIT A TABULATION WITH METER READING TO THE ENGINEER. ALL EXISTING DOMESTIC WATER METERS SHALL BE RETURNED TO THE ENGINEER.
- 3. PLUMBING PIPING BELOW GRADE MAY BE ABANDONED IN PLACE.

DEMOLITION NOTES

- 1. REFER TO MEP PLANS FOR FURTHER INFORMATION.
- 2. THE GENERAL CONTRACTOR IS RESPONSIBLE FOR BECOMING FAMILIAR WITH THE BUILDING RULES AND REGULATIONS BEFORE AND DURING THE COURSE OF CONSTRUCTION. SHOULD A CONFLICT ARISE BETWEEN THE CONTRACT DOCUMENTS AND THE BUILDING RULES, THE CONTRACTOR IS TO NOTIFY THE OWNER'S REPRESENTATIVE IMMEDIATELY. BUILDING RULES AND REGULATIONS SHALL GOVERN EXCEPT WHERE THEY ARE IN CONFLICT WITH APPLICABLE CODES AND ORDINANCES.
- 3. GENERAL CONTRACTOR IS TO COORDINATE ALL PHASES OF CONSTRUCTION FOR PROJECT AND NOTIFY THE OWNER'S REPRESENTATIVE OF ANY DISCREPANCIES OR CONFLICTING CONDITIONS WHICH WOULD INTERFERE WITH THE SATISFACTORY COMPLETION OF THE WORK PRIOR TO THE START OF CONSTRUCTION.
- 4. GENERAL CONTRACTOR IS RESPONSIBLE TO PROTECT ALL EXISTING ITEMS TO REMAIN THROUGHOUT THE COURSE OF DEMOLITION.
- 5. DEMOLITION SHALL BE DONE IN NEAT WORKMAN LIKE MANNER WITHIN THE LIMITS INDICATED IN THE DRAWINGS AND IN ALL CASES TO THE EXTENT NEEDED TO PRODUCE THE INTENDED WORK
- NEEDED TO PRODUCE THE INTENDED WORK.

 6. DEBRIS REMOVAL:
 THE CONTRACTOR IS RESPONSIBLE FOR DEMOLITION AND REMOVAL OF ALL
- SPACE.

 (A) THE CONTRACTOR IS RESPONSIBLE FOR REMOVAL OF MATERIALS FROM THE BUILDING PREMISES ON A DAILY BASIS. DO NOT MIX DEMOLITION DEBRIS WITH THAT OF BUILDING OCCUPANTS.

DEBRIS AND DISCARDED AND/OR EQUIPMENT AS INDICATED WITHIN THE

- 7. NOISE:
 ALL MAJOR DEMOLITION AND NOISE CREATING WORK SHALL OCCUR UNDER THE HOURS PER AIRPORT AUTHORITY'S RULES AND REGULATIONS.
- PROTECTION:

 (A) THE CONTRACTOR IS TO CONFIRM WITH AIRPORT AUTHORITY'S FIELD REPRESENTATIVE BEFORE THE START OF DEMOLITION WHICH ITEMS ARE TO BE SAVED FROM DEMOLITION. AIRPORT AUTHORITY TO DIRECT CONTRACTOR TO EITHER PROTECT THESE ITEMS OR REMOVE TO STORAGE.

 (B) THE CONTRACTOR IS TO CONFIRM WITH AIRPORT AUTHORITY BEFORE THE START OF DEMOLITION OF WHICH ITEMS INDICATED ON THE DRAWINGS ARE DEEMED TO BE NOT REQUIRED BY THE CLIENT AND ARE TO BE REMOVED FROM THE SITE.
- (C) THE CONTRACTOR IS RESPONSIBLE TO PROTECT ALL EXISTING ITEMS TO REMAIN (I.E. WINDOWS, DOORS, ETC.) THROUGHOUT THE COURSE OF DEMOLITION AND CONSTRUCTION.
 (D) THE CONTRACTOR MUST PROVIDE ALL REQUIRED PROTECTION TO ALL SURROUNDING AREAS THROUGHOUT THE COURSE OF DEMOLITION AND CONSTRUCTION. THERE IS TO BE NO DUST INFILTRATION BETWEEN EXISTING
- 9. REPAIR/DAMAGES:
 THE CONTRACTOR IS RESPONSIBLE TO REPAIR AND/OR REPLACE ANY
 DAMAGES IN THE SURROUNDING AREAS AND IN THE AREA OF WORK CAUSED
 BY DEMOLITION AND CONSTRUCTION PERFORMED IN THE AREA OF WORK.
- 10. THE CONTRACTOR SHALL BE RESPONSIBLE FOR ANY LOSSES INCURRED IN THE EVENT THAT THE LOSS OF ANY SERVICES PREVENTS THE AIRPORT AUTHORITY'S FROM CONDUCTING BUSINESS.
- 11. ALL DEMOLITION WORK SHALL BE COORDINATED WITH HAZMAT WORK.

OCCUPIED AND CONSTRUCTION AREAS.

2. CONTRACTOR TO PROVIDE TEMPORARY FIRE EXTINGUISHERS AS REQUIRED THROUGHOUT THE COURSE OF CONSTRUCTION.

13. REUSE OF MATERIA

GENERAL CONTRACTOR TO REMOVE FROM SITE ALL ITEMS DEEMED NOT REUSABLE BY THE AIRPORT AUTHORITY, GENERAL CONTRACTOR TO COORDINATE REUSE OF MATERIAL WITH THE AIRPORT AUTHORITY'S FIELD REPRESENTATIVE.

14. FLOORS:

- THE CONTRACTOR IS TO REMOVE ALL FINISH FLOORING TO SLAB WHERE NOTED ON THE DRAWINGS.
- (A) REMOVE RESILIENT FLOORING INCLUDING ALL FLOOR TILES. FOR FULL AREA OF WORK REMOVE MASTIC AS NECESSARY.
 (B) SLAB SHOULD BE LEFT IN A SMOOTH CONDITION FOR NEW FINISHES TO BE APPLIED LEVEL.

15. <u>BASE:</u>

INDICATED IN AREA OF WORK.

REPRESENTATIVE.

CONSTRUCTION WORK

- THE CONTRACTOR IS TO REMOVE ALL RESILIENT BASE WHERE INDICATED IN AREA OF WORK, UNLESS OTHERWISE NOTED.
- (A) WHERE NOTED, ALL CEILINGS IN THEIR ENTIRETY U.O.N., INCLUDING HUNG CEILING SYSTEM, PLASTER, GYPSUM WALL BOARD AND REGISTERS. COORDINATE W/ NEW CEILING MANUFACTURERS FOR THEIR PRACTICES & PROCEDURES FOR RECLAMATION & RECYCLE.
 (B) REMOVE ALL ASSOCIATED HANGERS, GGRID, ANCHORS, TILES, PAINT, ETC. BACK TO SLAB ABOVE.
- (C) REMOVE ALL EQUIPMENT INCLUDING SPEAKERS, DUCTS, DIFFUSERS, ETC. IN INDICATED AREAS, U.O.N.
- 17. <u>DOORS AND FRAMES:</u> REMOVE DOORS, FRAMES, THRESHOLDS AND RELATED HARDWARE, WHERE
- FINISHES:
 REMOVE ARCHITECTURAL FINISHES WHERE NOTED INCLUDING CARPET
 FLOORING, FLOOR TILES, WALLS, SOFFITS AND CEILINGS. SEE MEP DRAWINGS
- 19. <u>FURNITURE:</u>
 ALL FURNITURE AND SYSTEM FURNITURE IN THE AREA OF WORK SHALL REMAIN (U.O.N.) SEE NOTES ON DRAWINGS REGARDING TEMPORARY

FOR ADDITIONAL REMOVAL SCOPE OF WORK..

RELOCATION & STORAGE OF THESE ITEMS.

- 20. ANY REMOVAL AND ANY NEW ELECTRICAL / MECHANICAL / PLUMBING WORK ON THIS FLOOR AND ANY OTHER FLOOR SHALL OCCUR AS PER AIRPORT
- AUTHORITY'S HOUSE RULES.

 21. ALL REMOVALS OF EXISTING CABLING IN GENERAL TO BE DEMOLISHED SHOULD BE COORDINATED WITH THE AIRPORT AUTHORITY'S FIELD
- TEMPORARY POWER AND LIGHTING:
 PROVIDE THROUGHOUT COURSE OF DEMOLITION WHERE REQUIRED.
- 23. THE CONTRACTOR SHALL PROBE ALL WIRES/CABLES PRIOR TO REMOVAL TO INSURE THAT NO OPERATIONS ARE INADVERTENTLY INTERRUPTED. CONFIRM WIRE IS NON-ASBESTOS WITH AIRPORT AUTHORITY'S FIELD REPRESENTATIVE PRIOR TO REMOVAL.

TEMPORARY LIGHTING TO REMAIN ON JOB SITE WHEN DEMO IS COMPLETED.

- 24. FIRE ALARM:

 (A) FIRE AND SMOKE DETECTION SYSTEM (EXISTING) TO REMAIN IN OPERATION DURING DEMOLITION AND CONSTRUCTION INCLUDING ALL STROBES.

 (B) CONTRACTOR WILL BE RESPONSIBLE TO REPAIR FIRE ALARM SYSTEM IF WIRES ARE CUT. COORDINATE WITH BUILDING FIRE ALARM VENDOR.
- 25. <u>DUCTWORK:</u>
 REFER TO MEP PLANS FOR DETAILS. SEAL MAIN BRANCHES THAT ARE TO REMAIN IN USE TO PREVENT DUST INFILTRATION. COORDINATE WITH EXISTING DUCTWORK SERVING AREAS WHICH WILL REMAIN OCCUPIED. THERE SHALL BE NO INTERRUPTION OF MEP AND FIRE PROTECTION SERVICES IN AREAS WHICH REMAIN OCCUPIED DURITNG THE COURSE OF DEMOLITION AND NEW

SAFETY

- SAFETY DURING CONSTRUCTION AND DEMOLITION SHALL COMPLY WITH PENNSYLVANIA STATE BUILDING CODE, 2009 INTERNATIONAL BUILDING
- 2. THE CONTRACT DOCUMENTS DO NOT INCLUDE NECESSARY COMPONENTS FOR CONSTRUCTION SAFETY. THE CONTRACTOR HAS FULL RESPONSIBILITY FOR THE CONSTRUCTION PROCESS, SITE CONDITIONS, OPERATIONS, EQUIPMENT AND PERSONNEL, THE MAINTENANCE OF A SAFE WORKING ENVIRONMENT, AND SAFETY IN OR AROUND THE SITE OF WORK, AS MAINTAINED BY THE OCCUPATIONAL SAFETY AND HEALTH HAZARDS ASSOCIATION (OSHA) GUIDELINES.
- 3. THE CONTRACTOR IS SOLELY RESPONSIBLE FOR ALL SHORING, BRACING, ENCLOSURES, BARRIERS, SCAFFOLDING, ETC. AS REQUIRED TO PROVIDE A SAFE WORKING ENVIRONMENT AS DICTATED BY SITE CONDITIONS OR THE PROGRESS OF WORK, PROPERTY BELONGING TO THE OWNER SHALL BE PROTECTED THROUGHOUT THE WORK.
- DURING THE ENTIRE CONSTRUCTION PERIOD, ALL EXISTING LIGHTING, FIRE PROTECTION DEVICES AND ALARMS SHALL BE CONTINUOUSLY MAINTAINED IN CONFORMANCE WITH LOCAL BUILDING CODE AND OTHER GOVERNING ENTITY REQUIREMENTS.
- THE CONTRACTOR SHALL SAFE OFF AREA WHERE NEW WORK IS BEING PERFORMED, AND SHALL HAVE SOLE RESPONSIBILITY FOR PROTECTING ALL DANGEROUS AREAS FROM ENTRY BY UNAUTHORIZED PARTIES.
- 6. IN ACCORDANCE WITH STANDARD CODE REGULATIONS, A SAFETY BARRIER MUST BE ERECTED AROUND THE CONSTRUCTION AREAS FACING AREAS OF PEDESTRIAN TRAFFIC. COMPLY WITH OWNER APPROVED STANDARDS FOR BARRIER CONSTRUCTION AND/OR ALL AUTHORITIES HAVING JURISDICTION.
- 7. COMPLETE PROTECTION SHALL BE GIVEN TO ALL OWNER EQUIPMENT. THE ENTIRE CONSTRUCTION SITE SHALL BE SEPARATED FROM ADJACENT BUILDING AREAS BY MEANS OF A BARRIER OVER THE EXISTING FACADE. ALL ADJACENT AREAS SHALL BE KEPT FREE OF DUST AND CONSTRUCTION DEBRIS.
- . FIRE EXITS SHALL BE KEPT READILY ACCESSIBLE AND UNRESTRICTED AT ALL TIMES.
- BUILDING MATERIALS, TOOLS AND EQUIPMENT SHALL BE STORED WITHIN THE PREMISES AS APPROVED BY THE OWNER. AT NO TIME SHALL SUCH ITEMS BE STORED IN OPEN AREAS INCLUDING CORRIDORS OR STAIR WELLS.
- 10. SUBMIT TO THE AUTHORITY FOR REVIEW A SITE SAFETY PLAN(S) PREPARED AND SIGNED BY A PENNSYLVANIA STATE LICENSED SITE SAFETY MANAGER. THE PLAN(S) SHALL BE COMPLETE, REFLECTING THE ENTIRE SITE AND SHALL SHOW ANY PHASED PROTECTION.
- THE SITE SAFETY PLAN(S) SHALL INCLUDE, BUT SHALL NOT BE LIMITED TO NOTES, SIDEWALK BRIDGES, FENCES, EGRESS, SCAFFOLDING, FIRE PROTECTION, ETC. THEY SHOULD BE ADDRESS ANY POTENTIAL INTERACTION BETWEEN THE BUILDING OCCUPANTS AND GENERAL PUBLIC AND EXPOSURE TO THE CONSTRUCTION PROCESS.
- SEE SPECIFICATIONS GENERAL AND SPECIAL CONDITIONS FOR DETAILS.
 NO WORK IS TO PROCEED UNTIL SITE SAFETY PLANS ARE APPROVED BY THE AUTHORITY.

BELLA ABZUG PARK BLOCKS 5 & 6

CLIENT GROUP





DESIGNERS



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REVISIONS	

STATUS

NO. DATE DESCRIPTION

GENERAL
DEMOLITION NOTES

DRAWING NUMBER

G-002


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DATE 04/03/2020
SCALE 1/8" = 1'-0"
DRAWN BY D.SYROM
CHECKED BY W.LEE

SHEET NO. XX OF 11

24" x 36'



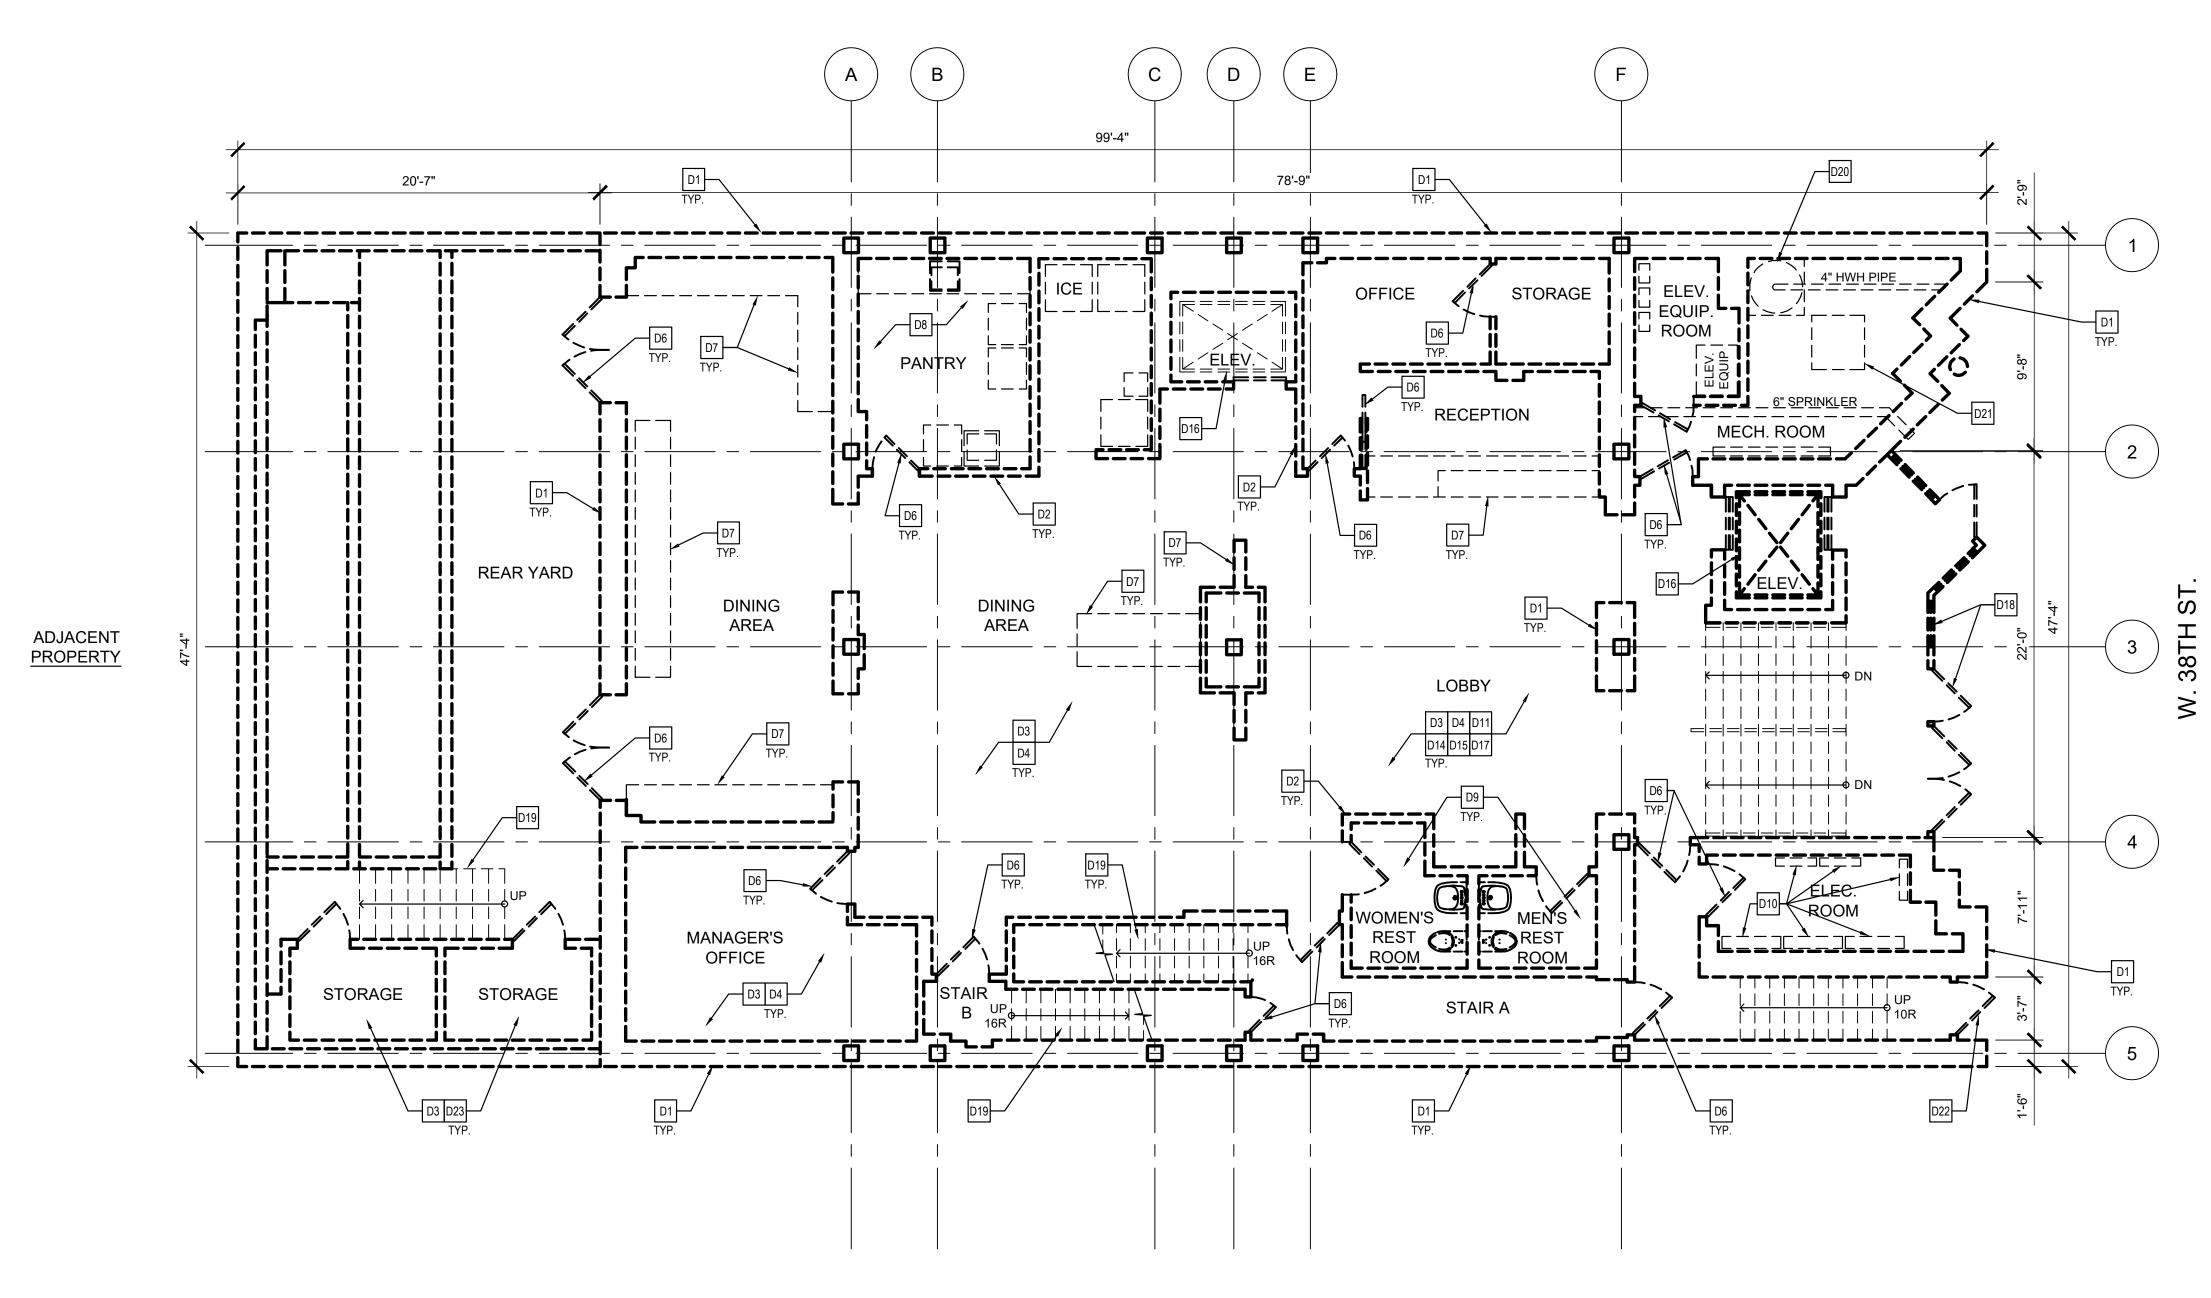

CELLAR LEVEL DEMOLITION PLAN

SCALE: 3/16" = 1'-0"

DEMOLITION KEY NOTES

- D1 EXISTING EXTERIOR MASONRY AND CONCRETE FOUNDATION WALLS TO BE REMOVED. U.O.N
- D2 EXISTING INTERIOR METAL FRAMED PARTITIONS TO BE REMOVED.

 D3 EXISTING CONCRETE SLAB TO BE REMOVED, TYP. U.O.N
- D4 REMOVE ALL INTERIOR FINISHES INCLUDING FLOORING (CARPET, VCT & PORCELAIN TILE), WALL BASE, WALL COVERING, ETC.
- D5 EXISTING WINDOWS AND WINDOW COVERING TO BE REMOVED THROUGHOUT.
- D6 EXISTING H.M. DOORS AND FRAMES TO BE REMOVED
- D7 REMOVE ALL MILLWORK AND BUILT-IN FURNISHINGS THROUGHOUT, INCLUDING BENCHES, COUNTERS, CABINETS AND SHELVING, ETC.
- D8 EXISTING WATER HEATERS, BOILER AND ALL ASSOCIATED PLUMBING PIPING, CONTROL PANELS AND WIRING TO BE REMOVED
- D9 REMOVE ALL EXISTING PLUMBING FIXTURES INCLUDING TOILETS, SINKS, BATHTUBS, AND ALL ASSOCIATED PLUMBING PIPING/DRAINAGE LINES. CUT AND CAP PLUMBING LINES AT THE BUILDING'S CONNECTION.
- D10 EXISTING ROOFING, WATERPROOFING, FLASHING, ROOF SLAB, ROOF DRAINS AND ASSOCIATED PIPING TO BE REMOVED
- REMOVE ALL EXISTING ELECTRICAL EQUIPMENT AND FIXTURES INCLUDING LIGHT FIXTURES, SWITCHES, OUTLETS, AND ALL ASSOCIATED CONDUITS AND WIRING.

- D12 EXISTING COMMUNICATION SYSTEM INCLUDING PANELS, DEVICES, OUTLETS, AND ALL ASSOCIATED WIRING AND CONDUITS TO BE REMOVED THROUGHOUT.
- D13 REMOVE EXISTING HVAC SYSTEM INCLUDING AIR DIFFUSERS, THERMOSTATS, AND ALL ASSOCIATED DUCTWORK, CONDUITS AND WIRING THROUGHOUT.
- D14 EXISTING FIRE PROTECTION SYSTEM INCLUDING SPRINKLERS, FIRE HOSE, AND ALL ASSOCIATED PIPING, RISER, VALVES, AND PUMPS TO BE REMOVED.
- D15 REMOVE EXISTING PLASTER CEILING THROUGHOUT.
- D16 EXISTING ELEVATOR SYSTEM, HOISTWAY STRUCTURE, ALL ASSOCIATED ACCESSORIES INCLUDING CONTROL PANELS AND ELECTRICAL SYSTEM TO BE REMOVED.
- D17 EXISTING FIRE ALARM SYSTEM, INCLUDING PANELS, STROBES, HORNS, AND ALL ASSOCIATED CONDUITS AND WIRING TO BE REMOVED.
- D18 REMOVE EXISTING GENERATOR AND STEEL SUPPORT STRUCTURES.
- D19 REMOVE EXISTING STAIRS AND RAILINGS THROUGHOUT, TYP.
- D20 REMOVE EXISTING ELEVATED WATER TANK, ASSOCIATED PIPING, AND STEEL SUPPORT STRUCTURE.

- D21 REMOVE ROOFTOP METAL GRATE PLATFORMS, CATWALK, STAIRS, RAILINGS, AND ALL ASSOCIATED METAL SUPPORT STRUCTURE.
- D22 EXISTING MASONRY PARAPET, FLASHING AND WATERPROOFING TO BVE REMOVED.

BELLA ABZUG PARK BLOCKS 5 & 6

CLIENT GROUP





Tel: 212.465.5000 Fax: 212.465.5584

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WITH THE DATE AND A SPECIFIC DESCRIPTION OF EACH ALTERATION.

STATUS

REVISIONS

NO. DATE DESCRIPTION

DRAWING TITLE

CELLAR FLOOR
DEMOLITION PLAN

DRAWING NUMBER

DM-100

Seal

 DATE
 04/03/2020


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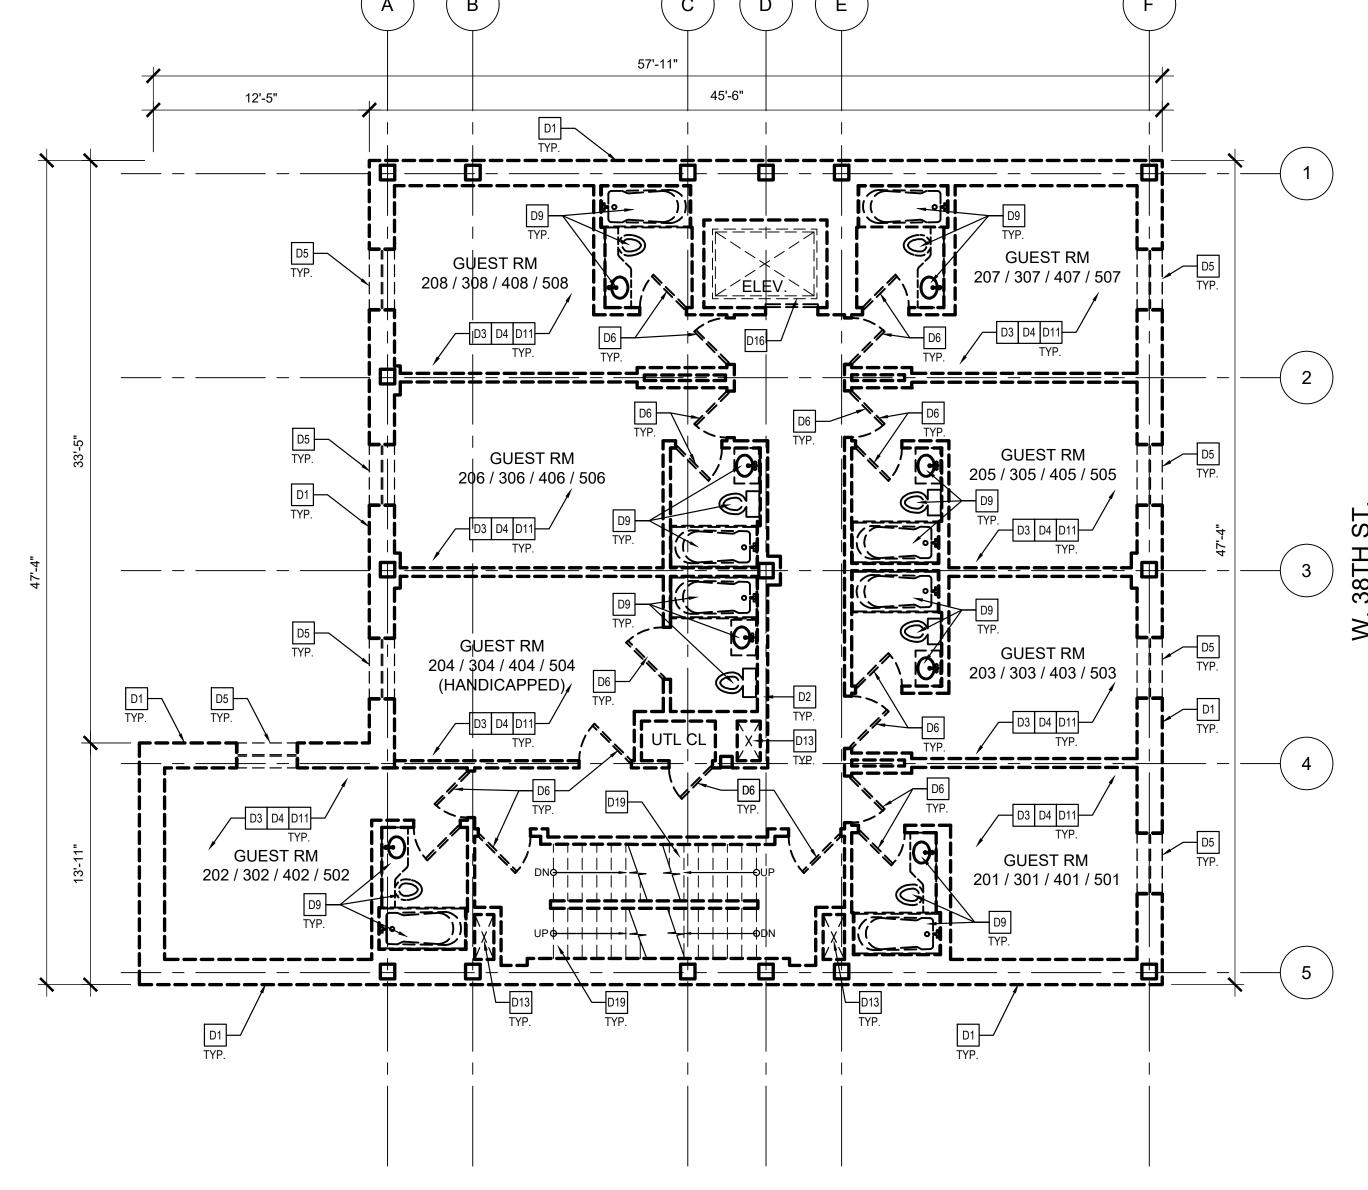
 DRAWN BY
 D.SYROM

 CHECKED BY
 W.LEE

SHEET NO. XX OF 11

24" x 36"



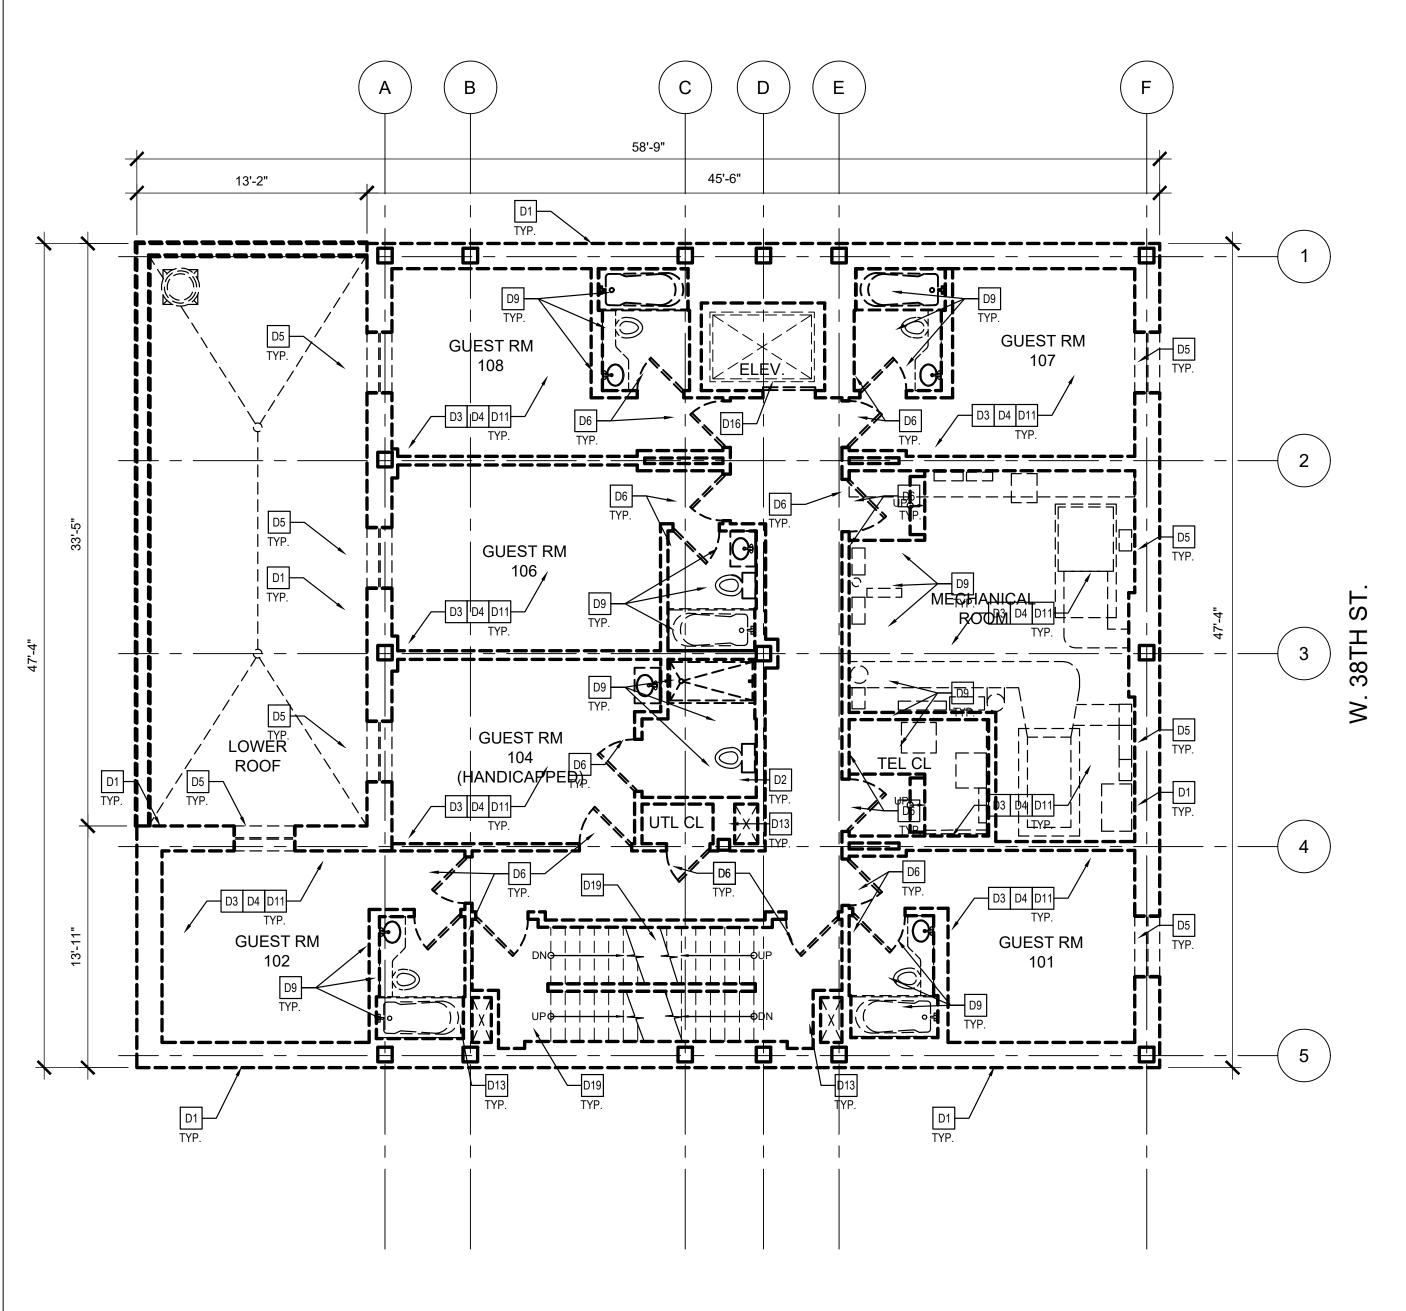

FIRST FLOOR DEMOLITION PLAN DM-101 / SCALE: 3/16" = 1'-0"



SCALE: 3/16" = 1'-0"



TYPICAL 2nd - 5th FLOOR DEMOLITION PLANS

<u>DEMOLITION KEY NOTES</u>

- EXISTING EXTERIOR MASONRY AND CONCRETE FOUNDATION WALLS TO D1 BE REMOVED. U.O.N
- D2 EXISTING INTERIOR METAL FRAMED PARTITIONS TO BE REMOVED.
- D3 EXISTING CONCRETE SLAB TO BE REMOVED, TYP. U.O.N
- D4 REMOVE ALL INTERIOR FINISHES INCLUDING FLOORING PORCELAIN TILE), WALL BASE, WALL COVERING, ETC. REMOVE ALL INTERIOR FINISHES INCLUDING FLOORING (CARPET, VCT &
- D5 EXISTING WINDOWS AND WINDOW COVERING TO BE REMOVED THROUGHOUT.
- D6 EXISTING H.M. DOORS AND FRAMES TO BE REMOVED
- REMOVE ALL MILLWORK AND BUILT-IN FURNISHINGS THROUGHOUT,
- D8 EXISTING WATER HEATERS, BOILER AND ALL ASSOCIATED PLUMBING PIPING, CONTROL PANELS AND WIRING TO BE REMOVED

CUT AND CAP PLUMBING LINES AT THE BUILDING'S CONNECTION.

INCLUDING BENCHES, COUNTERS, CABINETS AND SHELVING, ETC.

- REMOVE ALL EXISTING PLUMBING FIXTURES INCLUDING TOILETS, SINKS, BATHTUBS, AND ALL ASSOCIATED PLUMBING PIPING/DRAINAGE LINES.
- D10 EXISTING ROOFING, WATERPROUPING, LEGISLING, DRAINS AND ASSOCIATED PIPING TO BE REMOVED EXISTING ROOFING, WATERPROOFING, FLASHING, ROOF SLAB, ROOF
- D11 REMOVE ALL EXISTING ELECTRICAL EQUIPMENT AND FIXTURES INCLUDING LIGHT FIXTURES, SWITCHES, OUTLETS, AND ALL ASSO INCLUDING LIGHT FIXTURES, SWITCHES, OUTLETS, AND ALL ASSOCIATED CONDUITS AND WIRING.

- D12 EXISTING COMMUNICATION SYSTEM INCLUDING PANELS, DEVICES, OUTLETS, AND ALL ASSOCIATED WIRING AND CONDUITS TO BE REMOVED THROUGHOUT.
- D13 REMOVE EXISTING HVAC SYSTEM INCLUDING AIR DIFFUSERS, THERMOSTATS, AND ALL ASSOCIATED DUCTWORK, CONDUITS AND WIRING THROUGHOUT.
- D14 EXISTING FIRE PROTECTION SYSTEM INCLUDING SPRINKLERS, FIRE HOSE, AND ALL ASSOCIATED PIPING, RISER, VALVES, AND PUMPS TO BE
- D15 REMOVE EXISTING PLASTER CEILING THROUGHOUT.
- D16 EXISTING ELEVATOR SYSTEM, HOISTWAY STRUCTURE, ALL ASSOCIATED ACCESSORIES INCLUDING CONTROL PANELS AND ELECTRICAL SYSTEM TO BE REMOVED.
- D17 EXISTING FIRE ALARM SYSTEM, INCLUDING PANELS, STROBES, HORNS, AND ALL ASSOCIATED CONDUITS AND WIRING TO BE REMOVED.
- D18 REMOVE EXISTING GENERATOR AND STEEL SUPPORT STRUCTURES.
- REMOVE EXISTING STAIRS AND RAILINGS THROUGHOUT,
- D20 REMOVE EXISTING ELEVATED WATER TANK, ASSOCIATED PIPING, AND STEEL SUPPORT STRUCTURE.

D21 REMOVE ROOFTOP METAL GRATE PLATFORMS, CATWALK, STAIRS, RAILINGS, AND ALL ASSOCIATED METAL SUPPORT STRUCTURE.

D22 EXISTING MASONRY PARAPET, FLASHING AND WATERPROOFING TO BVE REMOVED.

BELLA ABZUG PARK BLOCKS 5 & 6

CLIENT GROUP





DESIGNERS

Tel: 212.465.5000 Fax: 212.465.5584


WARNING: IT IS A VIOLATION OF NEW YORK LAW FOR ANY PERSON, UNLESS ACTING UNDER THE DIRECTION OF A LICENSED ARCHITECT, LANDSCAPE ARCHITECT, PROFESSIONAL ENGINEER, OR LAND SURVEYOR (AS APPLICABLE) TO ALTER ANY ITEM SHOWN ON THIS DOCUMENT IN ANY WAY. IF A DOCUMENT OR ITEM BEARING THE SEAL OF ANY SUCH LICENSED PROFESSIONAL IS ALTERED, THE ALTERING ARCHITECT, LANDSCAPE ARCHITECT, PROFESSIONAL ENGINEER, OR LAND SURVEYOR SHALL AFFIX TO EACH ALTERED ITEM THEIR SEAL WITH THE NOTATION "ALTERED BY" FOLLOWED BY THEIR SIGNATURE WITH THE DATE AND A SPECIFIC DESCRIPTION OF EACH ALTERATION.


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1ST	FLOC	OR &TYPICAL 2ND-5TH	
	FLO	OR DEMO. PLANS	

DRAWING NUMBER DM-101


04/03/2020 SCALE 1/8" = 1'-0" DRAWN BY D.SYROM CHECKED BY W.LEE SHEET NO. XX OF 11



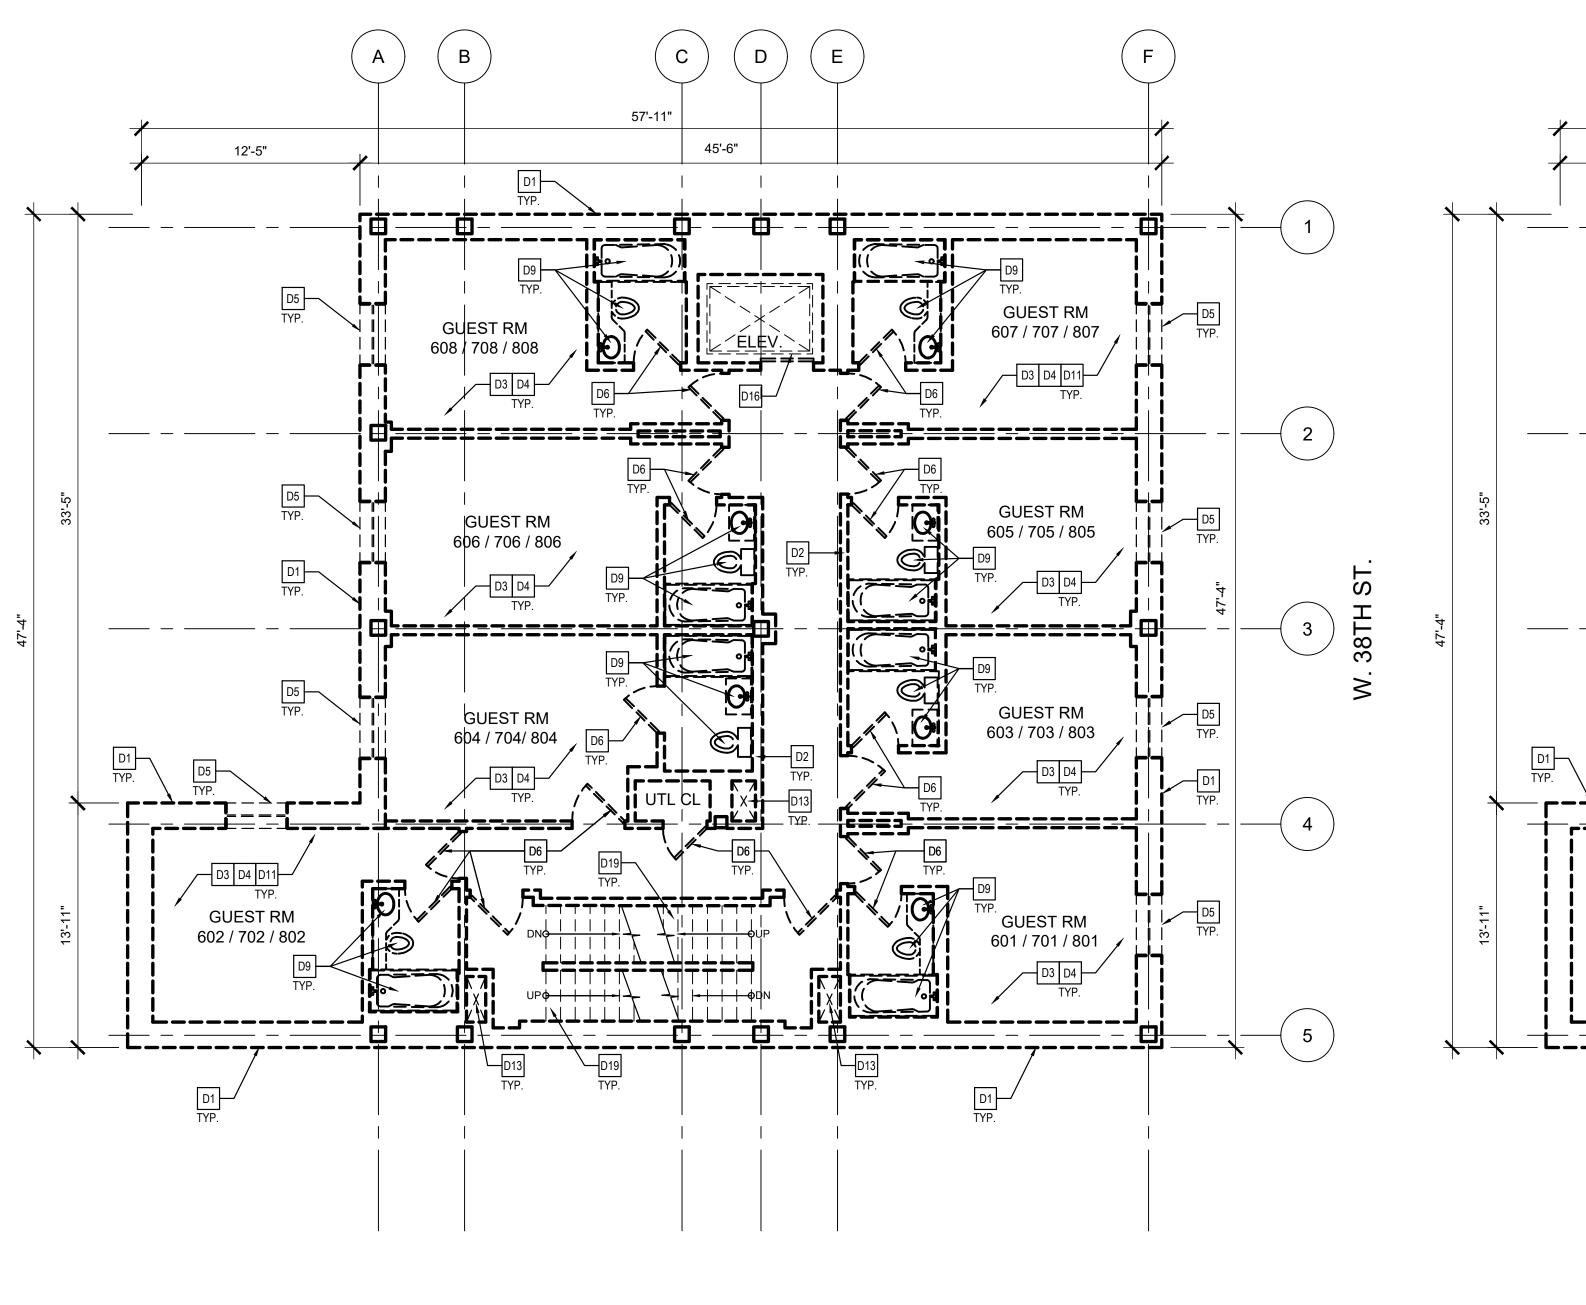


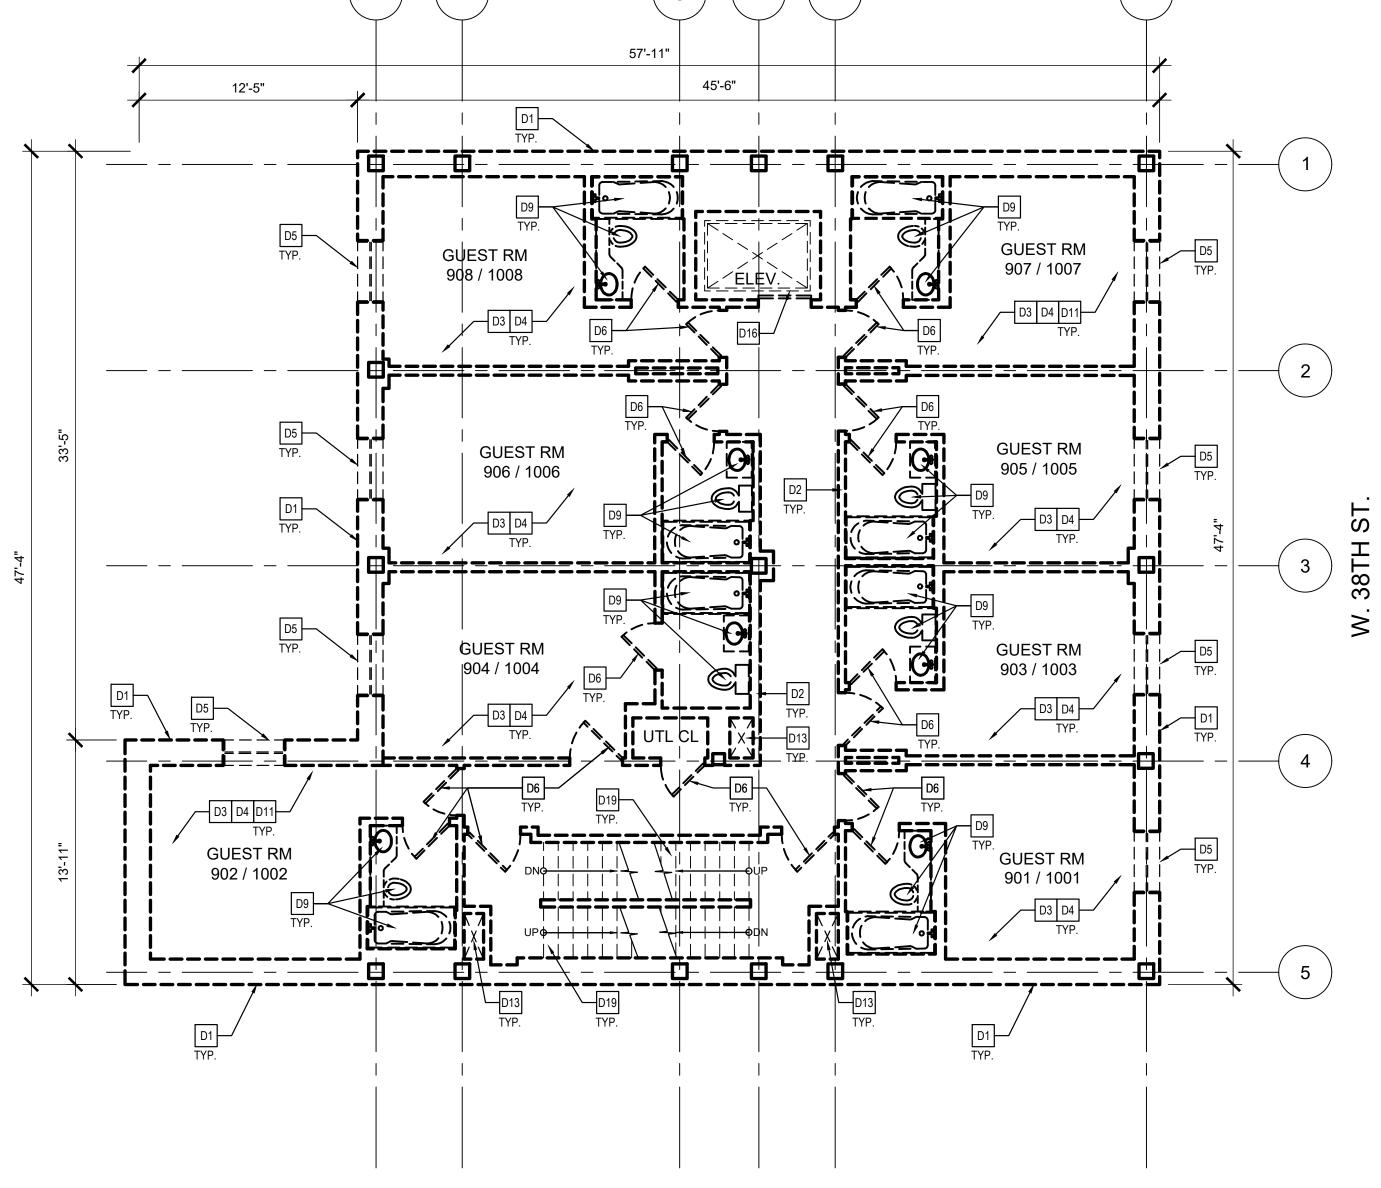TYPICAL 6th- 8th FLOOR DEMOLITION PLANS



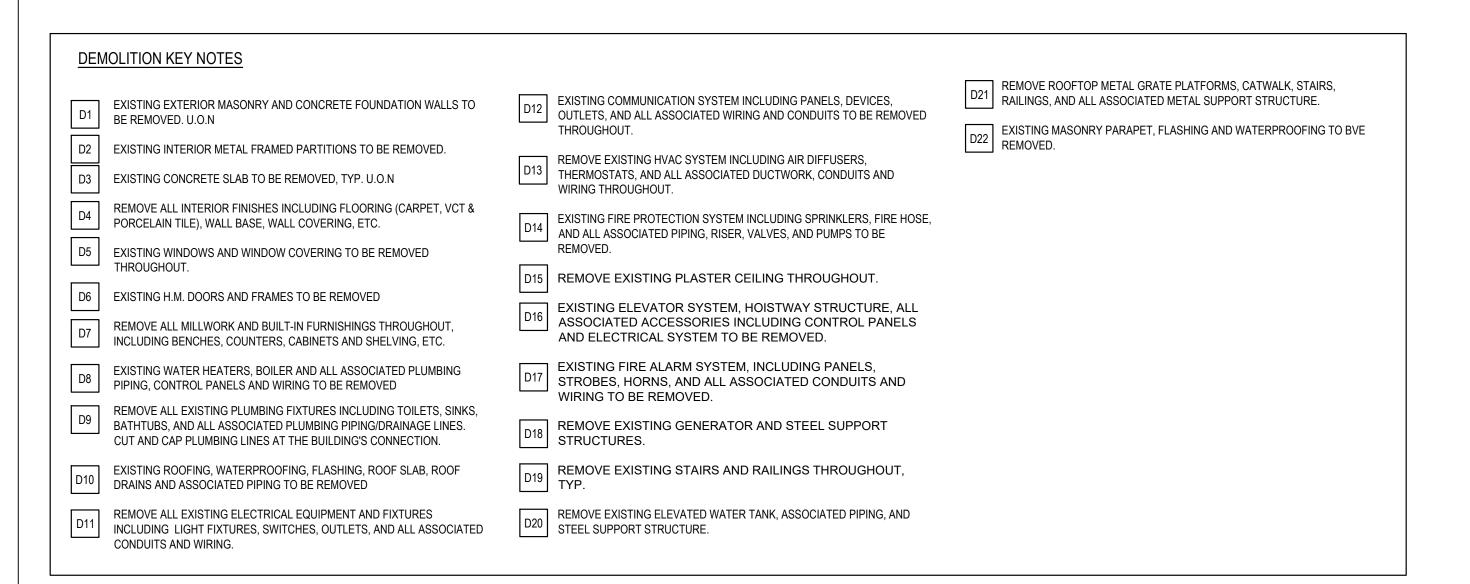

TYPICAL 9th - 10th FLOOR DEMOLITION PLANS

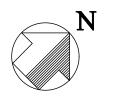

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NOT FOR CONSTRUCTION

STATUS

REVISIONS

NO. DATE DESCRIPTION

TYPICAL 6TH-8TH & 9TH-10TH FLOOR DEMO. PLANS

DRAWING NUMBER

DM-102


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SCALE

04/03/2020 1/8" = 1'-0" DRAWN BY D.SYROM CHECKED BY W.LEE

24" x 36"

SHEET NO. XX OF 11

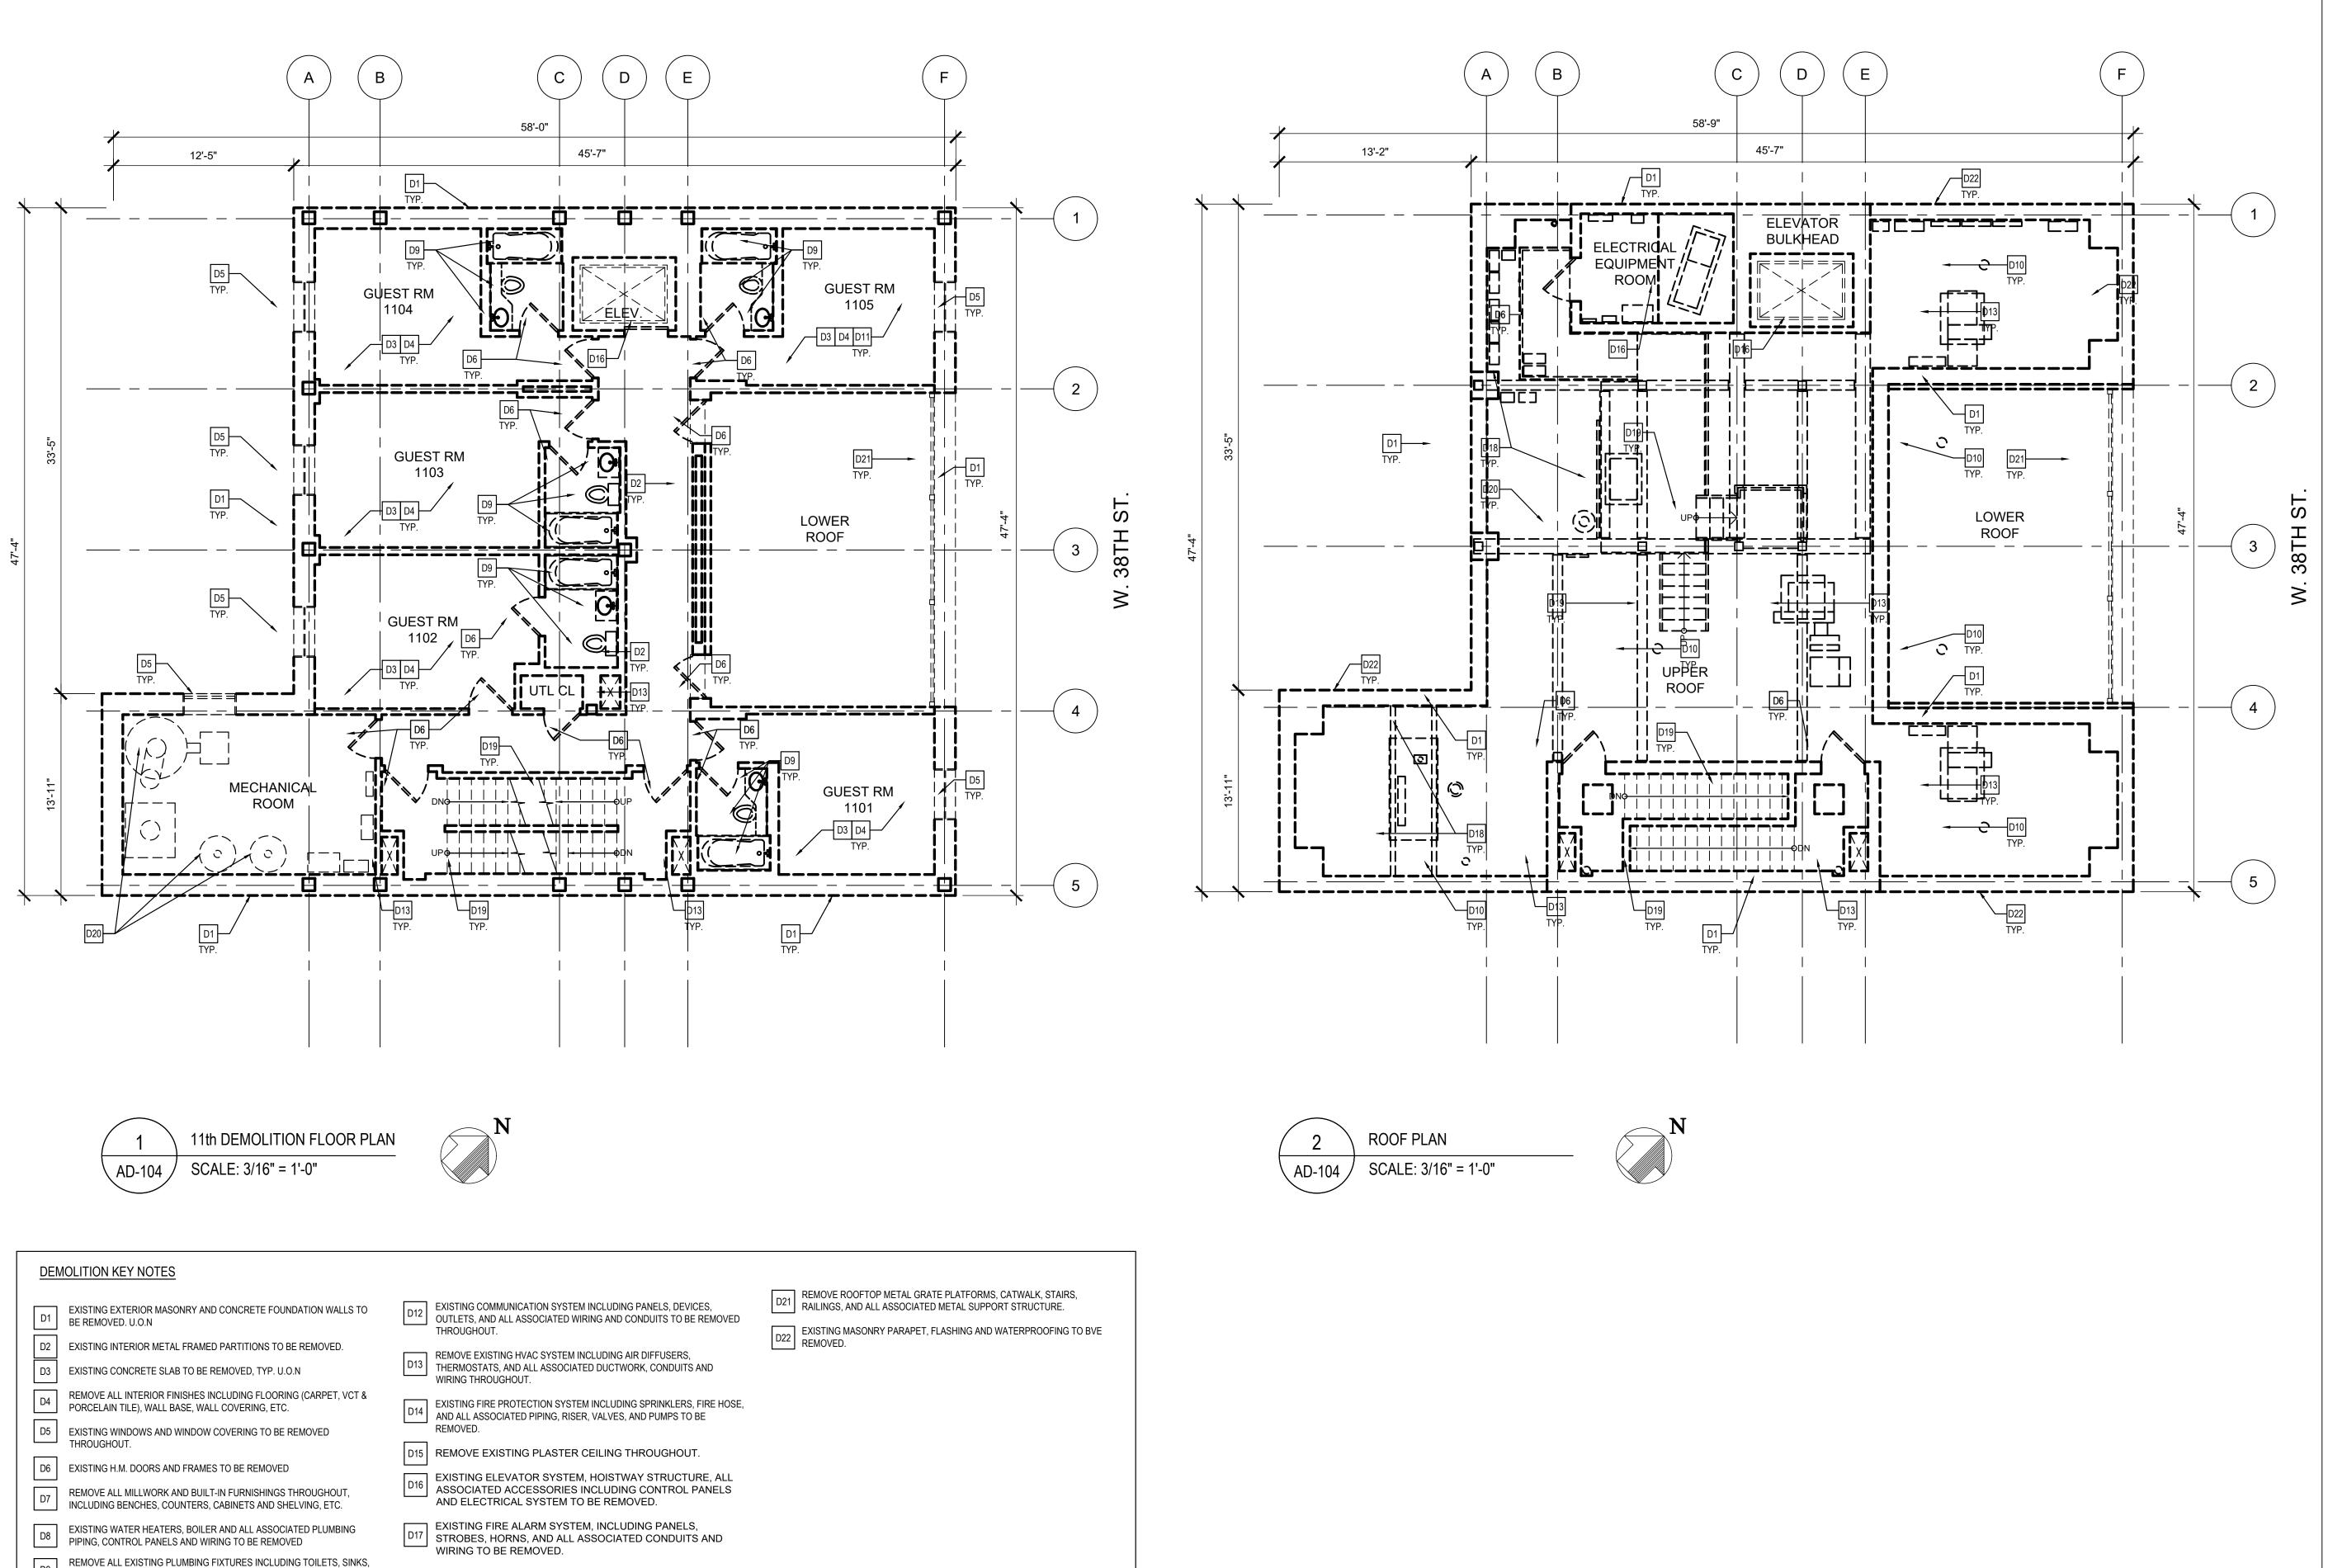

D18 REMOVE EXISTING GENERATOR AND STEEL SUPPORT STRUCTURES.

D19 REMOVE EXISTING STAIRS AND RAILINGS THROUGHOUT, TYP.

D20 REMOVE EXISTING ELEVATED WATER TANK, ASSOCIATED PIPING, AND STEEL SUPPORT STRUCTURE.

BATHTUBS, AND ALL ASSOCIATED PLUMBING PIPING/DRAINAGE LINES. CUT AND CAP PLUMBING LINES AT THE BUILDING'S CONNECTION.

EXISTING ROOFING, WATERPROOFING, FLASHING, ROOF SLAB, ROOF

INCLUDING LIGHT FIXTURES, SWITCHES, OUTLETS, AND ALL ASSOCIATED

REMOVE ALL EXISTING ELECTRICAL EQUIPMENT AND FIXTURES

DRAINS AND ASSOCIATED PIPING TO BE REMOVED

CONDUITS AND WIRING.

BELLA ABZUG PARK BLOCKS 5 & 6

CLIENT GROUP








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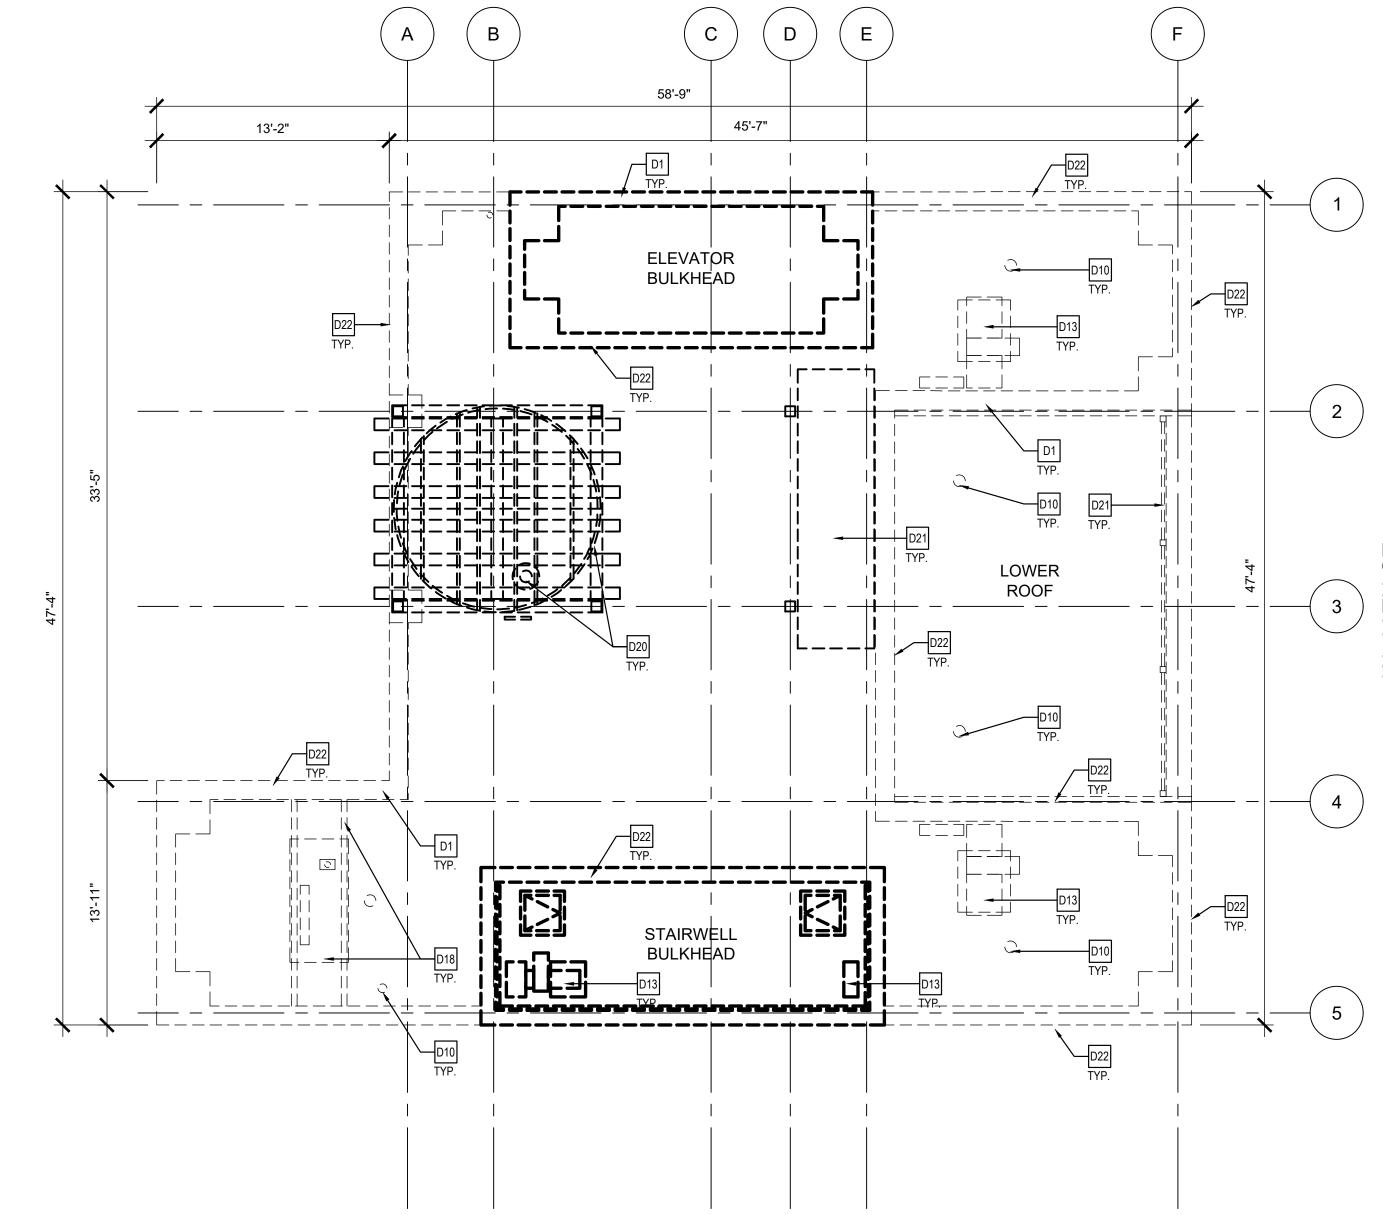
NOT FOR CONSTRUCTION

STATUS REVISIONS NO. DATE DESCRIPTION DRAWING TITLE 11TH FLOOR & ROOF LEVEL DEMO. PLANS

DM-103

04/03/2020 SCALE 1/8" = 1'-0" DRAWN BY D.SYROM CHECKED BY W.LEE SHEET NO. XX OF 11



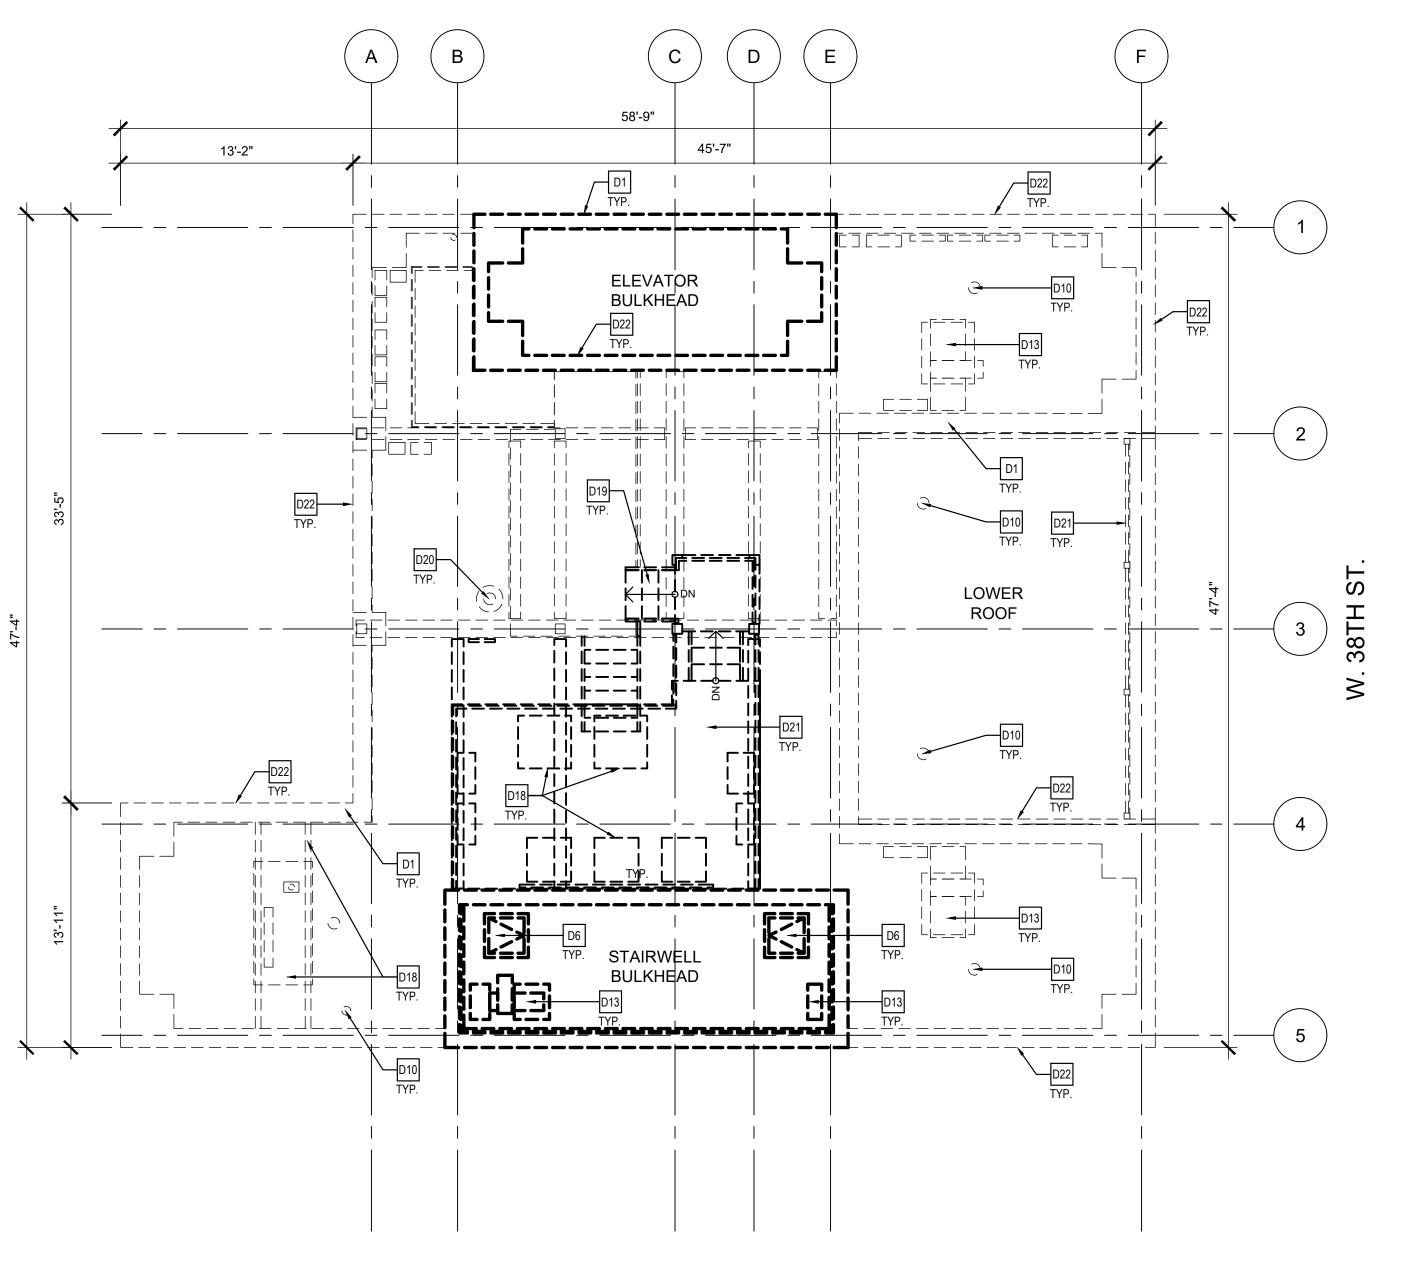

ELECTRICAL PLATFORM DEMOLITION PLAN



<u>DEMOLITION KEY NOTES</u>

- EXISTING EXTERIOR MASONRY AND CONCRETE FOUNDATION WALLS TO D1 BE REMOVED. U.O.N
- D2 EXISTING INTERIOR METAL FRAMED PARTITIONS TO BE REMOVED. EXISTING CONCRETE SLAB TO BE REMOVED, TYP. U.O.N
- REMOVE ALL INTERIOR FINISHES INCLUDING FLOORING (CARPET, VCT & PORCELAIN TILE), WALL BASE, WALL COVERING, ETC.
- D5 EXISTING WINDOWS AND WINDOW COVERING TO BE REMOVED THROUGHOUT.
- D6 EXISTING H.M. DOORS AND FRAMES TO BE REMOVED
- REMOVE ALL MILLWORK AND BUILT-IN FURNISHINGS THROUGHOUT,
- INCLUDING BENCHES, COUNTERS, CABINETS AND SHELVING, ETC.
- EXISTING WATER HEATERS, BOILER AND ALL ASSOCIATED PLUMBING PIPING, CONTROL PANELS AND WIRING TO BE REMOVED
- REMOVE ALL EXISTING PLUMBING FIXTURES INCLUDING TOILETS, SINKS, D9 BATHTUBS, AND ALL ASSOCIATED PLUMBING PIPING/DRAINAGE LINES. CUT AND CAP PLUMBING LINES AT THE BUILDING'S CONNECTION.
- EXISTING ROOFING, WATERPROOFING, FLASHING, ROOF SLAB, ROOF DRAINS AND ASSOCIATED PIPING TO BE REMOVED
- REMOVE ALL EXISTING ELECTRICAL EQUIPMENT AND FIXTURES D11 INCLUDING LIGHT FIXTURES, SWITCHES, OUTLETS, AND ALL ASSOCIATED CONDUITS AND WIRING.

- D12 EXISTING COMMUNICATION SYSTEM INCLUDING PANELS, DEVICES, OUTLETS, AND ALL ASSOCIATED WIRING AND CONDUITS TO BE REMOVED THROUGHOUT.
- REMOVE EXISTING HVAC SYSTEM INCLUDING AIR DIFFUSERS, D13 THERMOSTATS, AND ALL ASSOCIATED DUCTWORK, CONDUITS AND WIRING THROUGHOUT.
- EXISTING FIRE PROTECTION SYSTEM INCLUDING SPRINKLERS, FIRE HOSE, AND ALL ASSOCIATED PIPING, RISER, VALVES, AND PUMPS TO BE
- D15 REMOVE EXISTING PLASTER CEILING THROUGHOUT.
- D16 EXISTING ELEVATOR SYSTEM, HOISTWAY STRUCTURE, ALL ASSOCIATED ACCESSORIES INCLUDING CONTROL PANELS AND ELECTRICAL SYSTEM TO BE REMOVED.
- D17 EXISTING FIRE ALARM SYSTEM, INCLUDING PANELS, STROBES, HORNS, AND ALL ASSOCIATED CONDUITS AND WIRING TO BE REMOVED.
- D18 REMOVE EXISTING GENERATOR AND STEEL SUPPORT STRUCTURES.
- D19 REMOVE EXISTING STAIRS AND RAILINGS THROUGHOUT, TYP.
- REMOVE EXISTING ELEVATED WATER TANK, ASSOCIATED PIPING, AND D20 STEEL SUPPORT STRUCTURE.

- D21 REMOVE ROOFTOP METAL GRATE PLATFORMS, CATWALK, STAIRS, RAILINGS, AND ALL ASSOCIATED METAL SUPPORT STRUCTURE.
- D22 EXISTING MASONRY PARAPET, FLASHING AND WATERPROOFING TO BVE REMOVED.





WATER TOWER PLATFORM DEMOLITION PLAN

BELLA ABZUG PARK BLOCKS 5 & 6

CLIENT GROUP





DESIGNERS Tel: 212.465.5000 Fax: 212.465.5584

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NOT FOR CONSTRUCTION

STATUS

REVISIONS

NO. DATE DESCRIPTION

ELECTRICAL PLATFORMS & WATER TOWER DEMO. PLANS

DRAWING NUMBER

DM-104

DATE SCALE DRAWN BY CHECKED BY


SHEET NO. XX OF 11 24" x 36"


04/03/2020

1/8" = 1'-0"


D.SYROM

W.LEE

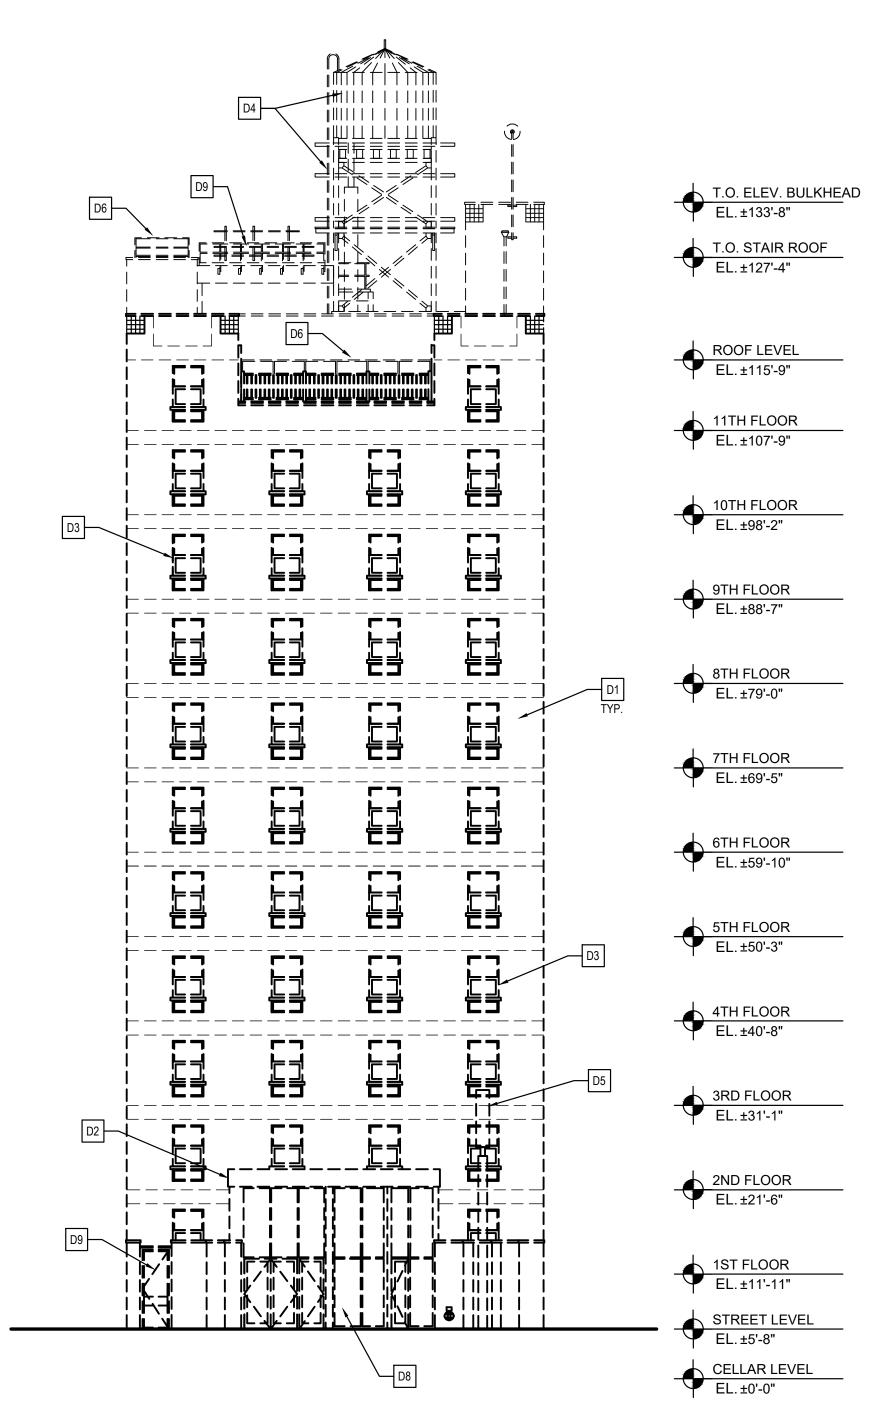

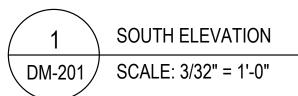

DEMOLITION KEY NOTES 11 EXISTING EXTERIOR MASONRY AND CONCRETE FOUNDATION WALLS TO BE REMOVED. U.O.N 12 EXISTING EXTERIOR METAL ENTRY CANOPY TO BE REMOVED. 13 REMOVE ALL WINDOWS INCLUDING FRAMES AND GLAZING THROUGHOUT. 14 REMOVE EXISTING WATER TOWER AND ALL ASSOCIATED SUPPORT STRUCTURE. 15 REMOVE EXISTING ELECTRONIC SIGNAGE AND STRUCTURE. 16 EXISTING METAL RAILINGS TO BE REMOVED, TYP. 17 EXISTING CELLULAR/COMMUNICATION ANTENNAS TO BE REMOVED BY OTHERS PRIOR TO DEMOLITION. COORDINATE SCHEDULING OF REMOVAL WITH OWNER. 18 REMOVE EXISTING SYSTEM IN ITS ENTIRETY. 19 REMOVE EXISTING ROOFTOP METAL GRATING PLATFORM, STAIRS, AND ALL SUPPORTING STRUCTURE THROUGHOUT.

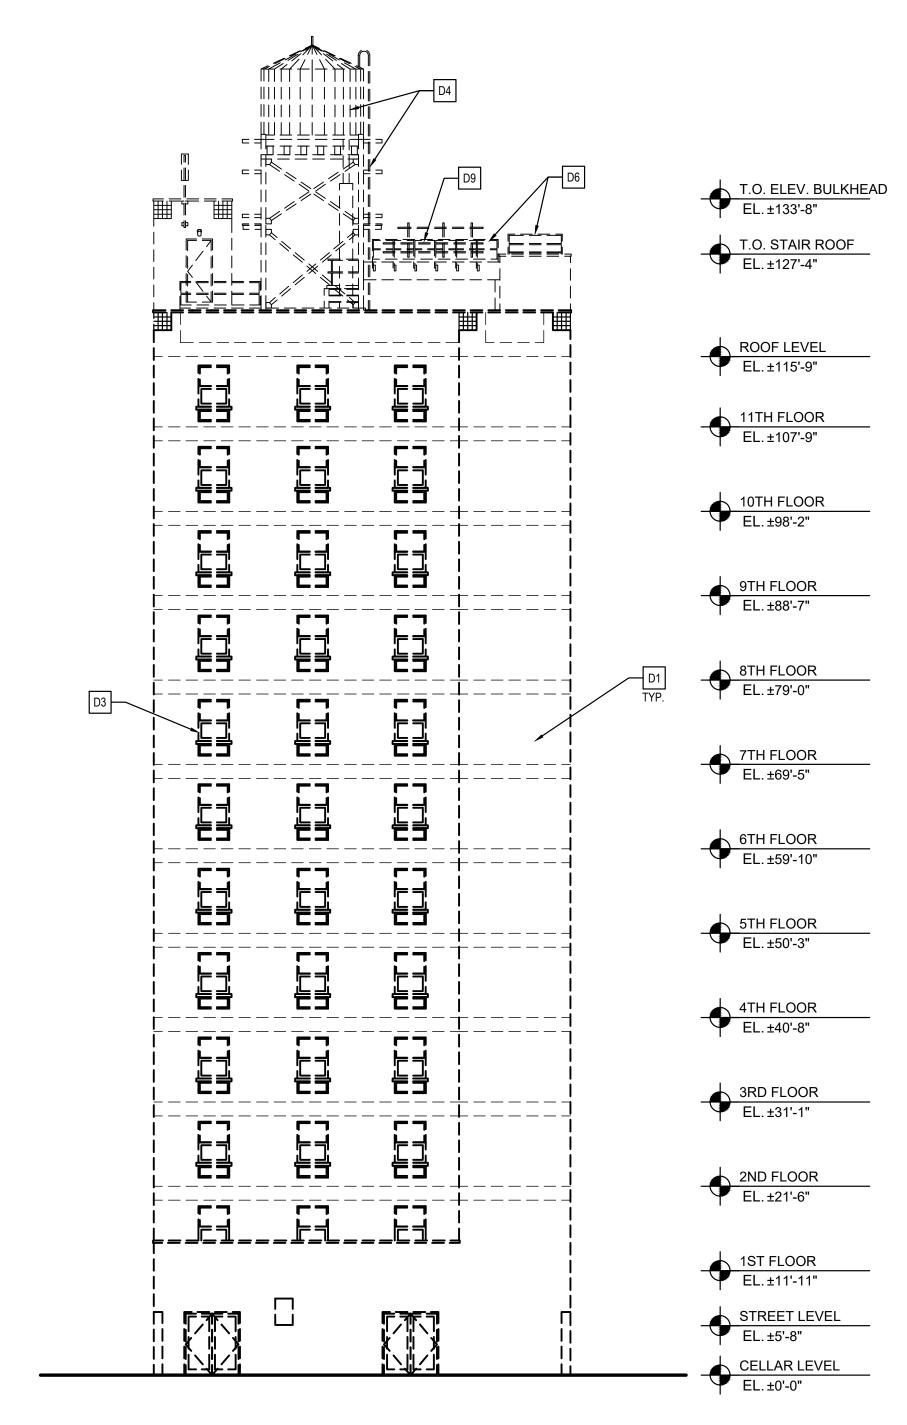

2 NORTH ELEVATION
DM-201 SCALE: 3/32" = 1'-0"

BELLA ABZUG PARK BLOCKS 5 & 6

CLIENT GROUP

HY



Tel: 212.465.5000 Fax: 212.465.5584

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NOT FOR CONSTRUCTION

STATUS

REVISIONS

NO. DATE DESCRIPTION

NORTH & SOUTH DEMOLITION

EXTERIOR ELEVATIONS

DRAWING NUMBER

DM-201

DATE SCALE DRAWN BY


 DATE
 04/03/2020

 SCALE
 3/32" = 1'-0"

 DRAWN BY
 D.SYROM

 CHECKED BY
 W.LEE

SHEET NO. XX OF 11 24" x 36"

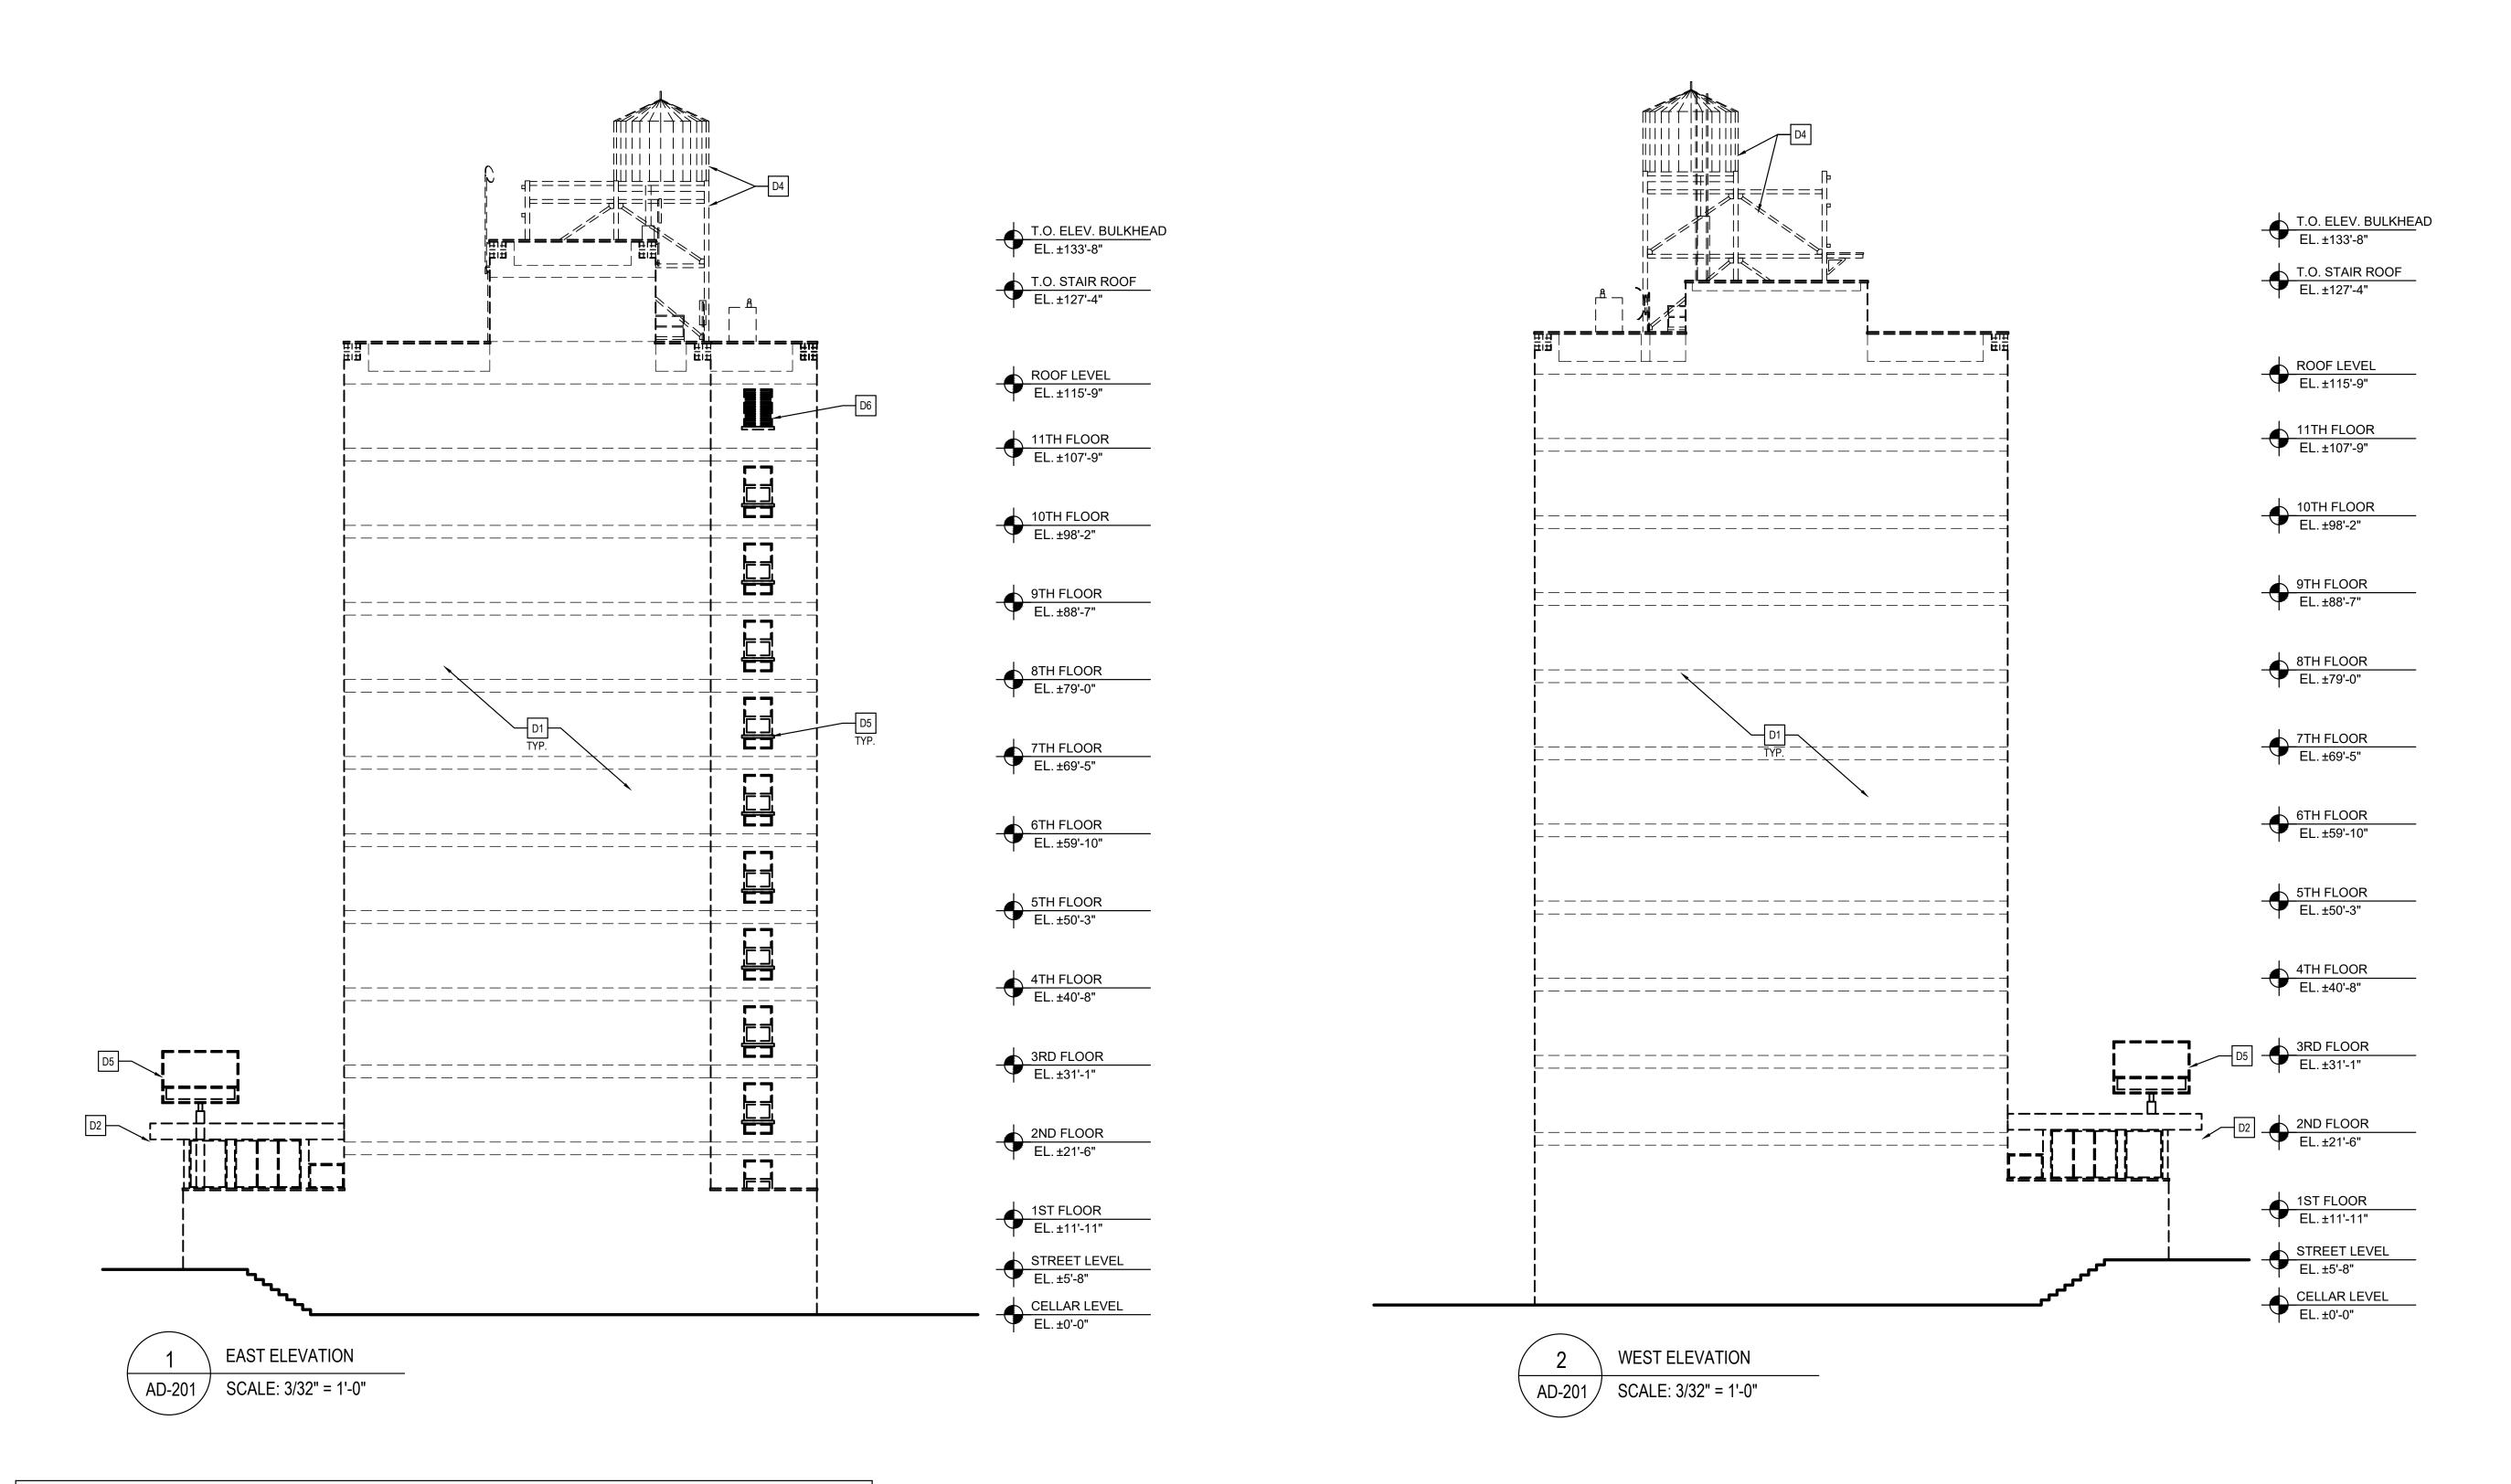

DEMOLITION KEY NOTES D1 EXISTING EXTERIOR MASONRY AND CONCRETE FOUNDATION WALLS TO BE REMOVED. U.O.N D2 EXISTING EXTERIOR METAL ENTRY CANOPY TO BE REMOVED. REMOVE ALL WINDOWS INCLUDING FRAMES AND GLAZING THROUGHOUT. REMOVE EXISTING WATER TOWER AND ALL ASSOCIATED SUPPORT STRUCTURE. D5 REMOVE EXISTING ELECTRONIC SIGNAGE AND STRUCTURE. D6 EXISTING METAL RAILINGS TO BE REMOVED, TYP. EXISTING CELLULAR/COMMUNICATION ANTENNAS TO BE REMOVED BY OTHERS PRIOR TO DEMOLITION. COORDINATE SCHEDULING OF REMOVAL WITH OWNER. REMOVE EXISTING SYSTEM IN ITS ENTIRETY. REMOVE EXISTING ROOFTOP METAL GRATING PLATFORM, STAIRS, AND ALL SUPPORTING STRUCTURE THROUGHOUT.

BELLA ABZUG PARK BLOCKS 5 & 6

CLIENT GROUP



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STATUS

REVISIONS NO. DATE DESCRIPTION

DRAWING TITLE

EAST & WEST DEMOLITION EXTERIOR ELEVATIONS

DRAWING NUMBER


DM-202

DATE

04/03/2020 SCALE 3/32" = 1'-0" DRAWN BY D.SYROM CHECKED BY W.LEE

SHEET NO. XX OF 11

24" x 36"

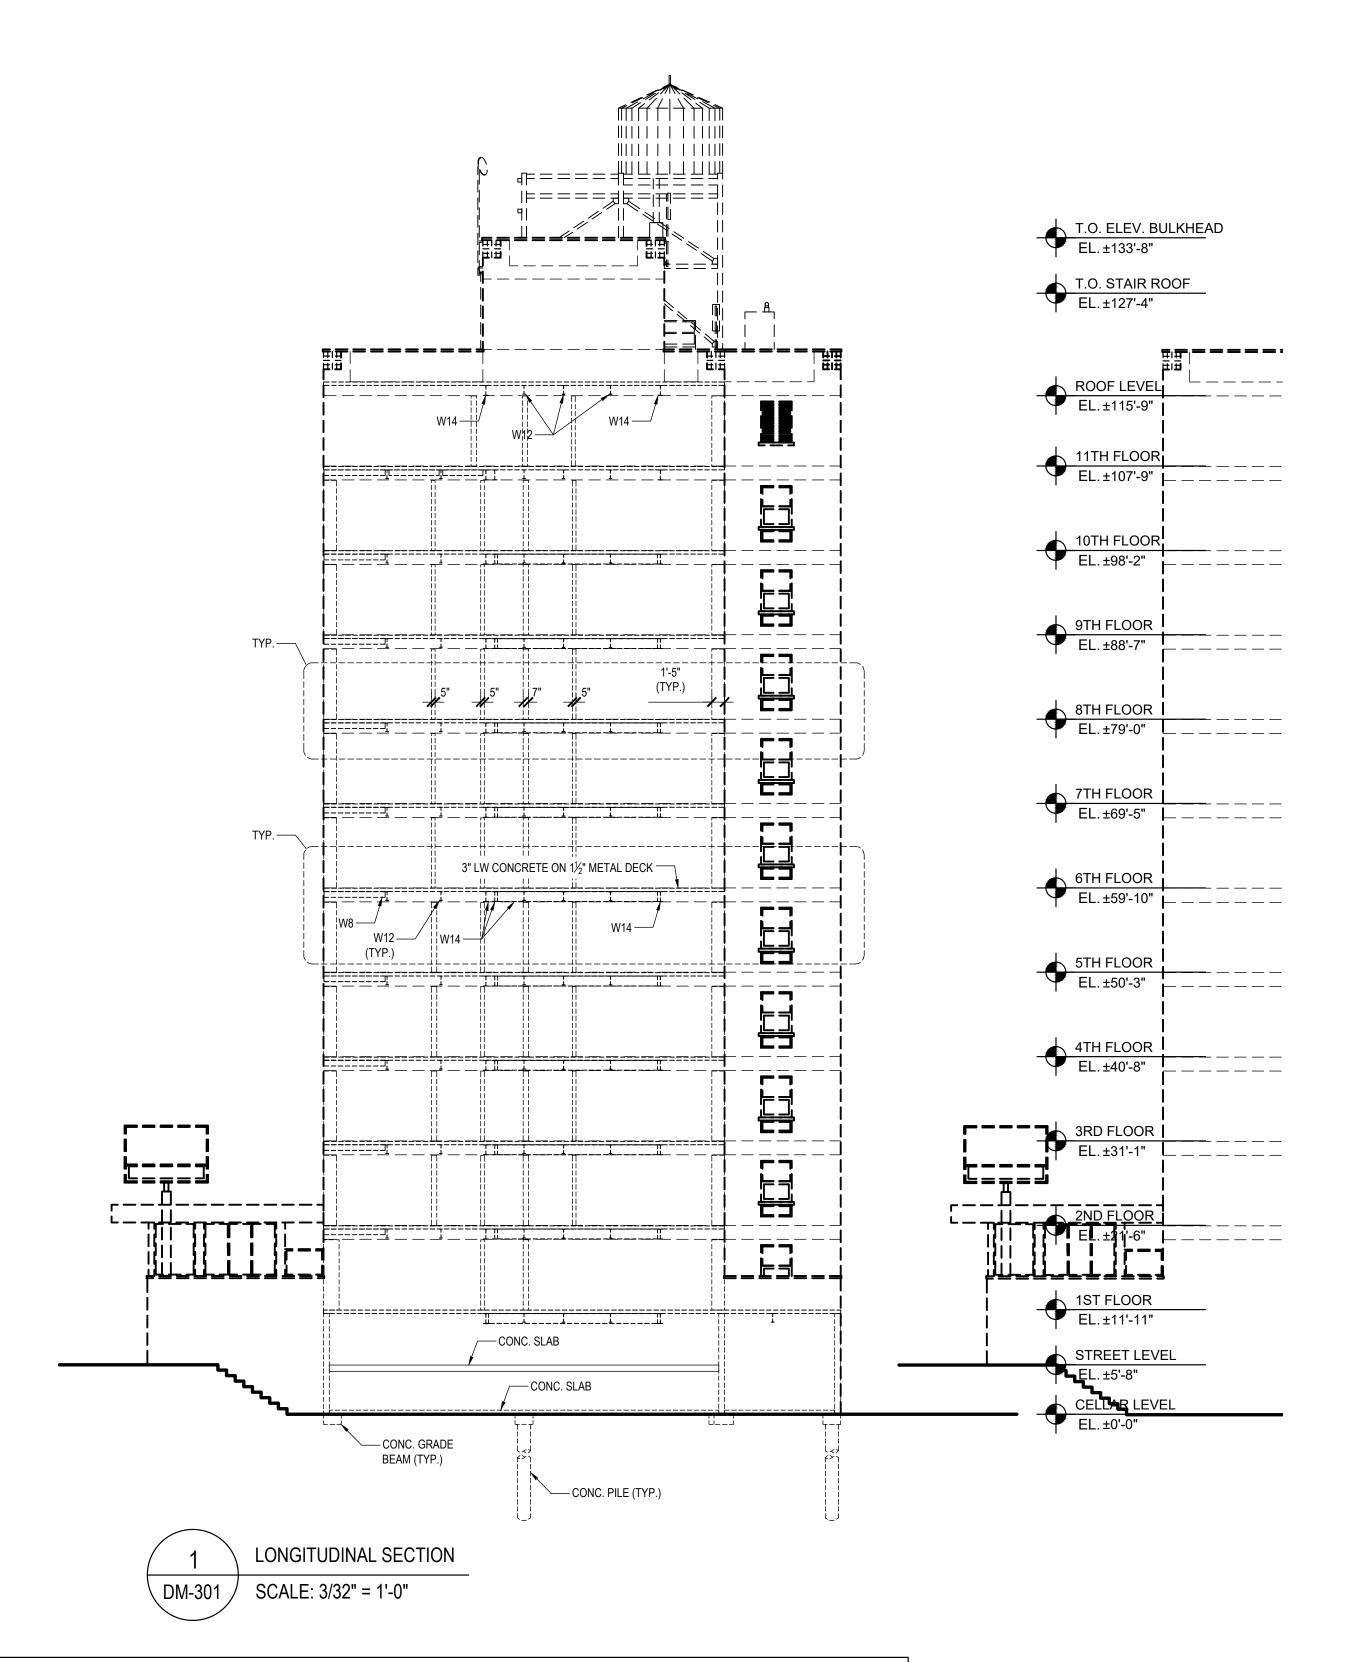

DEMOLITION KEY NOTES D1 EXISTING EXTERIOR MASONRY AND CONCRETE FOUNDATION WALLS TO BE REMOVED. U.O.N D2 EXISTING EXTERIOR METAL ENTRY CANOPY TO BE REMOVED. REMOVE ALL WINDOWS INCLUDING FRAMES AND GLAZING THROUGHOUT. REMOVE EXISTING WATER TOWER AND ALL ASSOCIATED SUPPORT STRUCTURE. D5 REMOVE EXISTING ELECTRONIC SIGNAGE AND STRUCTURE. D6 EXISTING METAL RAILINGS TO BE REMOVED, TYP. D7 EXISTING CELLULAR/COMMUNICATION ANTENNAS TO BE REMOVED BY OTHERS PRIOR TO DEMOLITION. COORDINATE SCHEDULING OF REMOVE OTHERS PRIOR TO DEMOLITION. COORDINATE SCHEDULING OF REMOVAL WITH OWNER. REMOVE EXISTING SYSTEM IN ITS ENTIRETY. REMOVE EXISTING ROOFTOP METAL GRATING PLATFORM, STAIRS, AND ALL SUPPORTING STRUCTURE THROUGHOUT.

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DESIGNERS



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STATUS

REVISIONS

NO.	DATE	DESCRIPTION
DRAWING TITLE		

STRUCTURAL DEMOLITION SECTIONS


DRAWING NUMBER

DM-301

DATE 04/03/2020 SCALE 3/32" = 1'-0" DRAWN BY B. LING F. PORTUGUEZ CHECKED BY

SHEET NO. 10 OF 11

24" x 36"

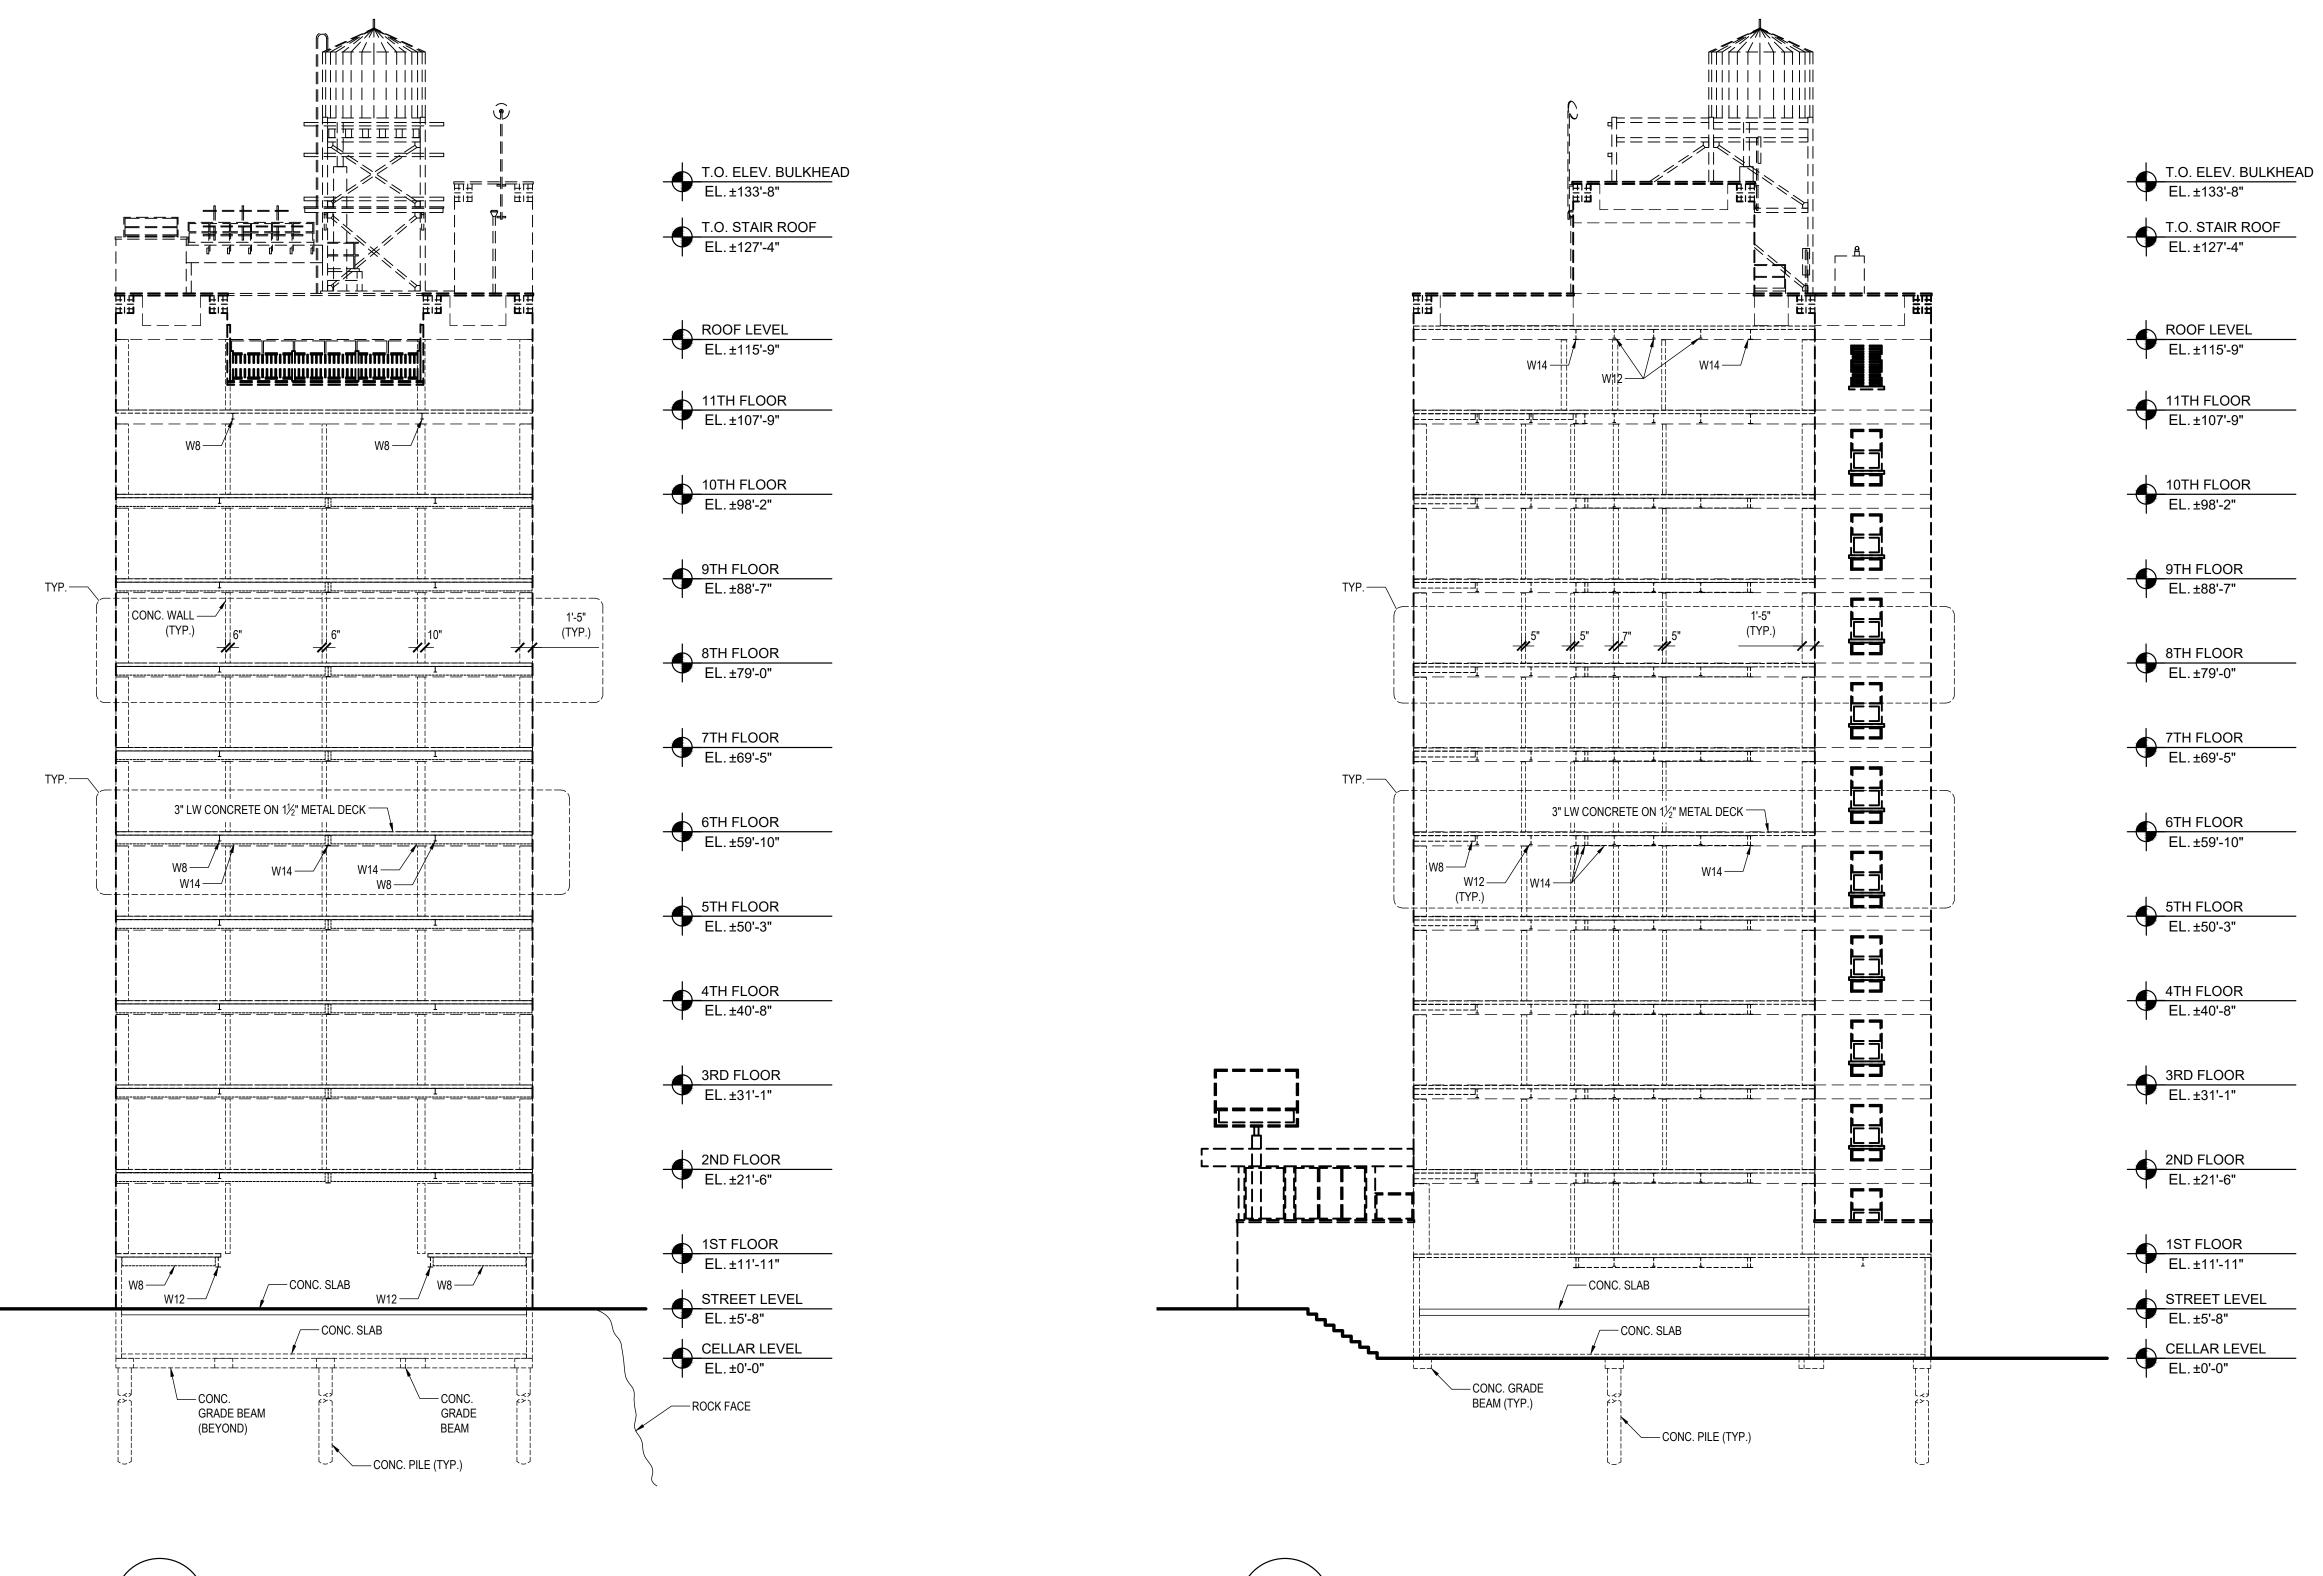

1 CROSS SECTION

DM-302 SCALE: 3/32" = 1'-0"

2 CROSS SECTION

DM-302 SCALE: 3/32" = 1'-0"

DEMOLITION KEY NOTES

D1 EXISTING EXTERIOR MASONRY AND CONCRETE FOUNDATION WALLS TO BE REMOVED. U.O.N

D2 EXISTING EXTERIOR METAL ENTRY CANOPY TO BE REMOVED.

D3 REMOVE ALL WINDOWS INCLUDING FRAMES AND GLAZING THROUGHOUT.

D4 REMOVE EXISTING WATER TOWER AND ALL ASSOCIATED SUPPORT STRUCTURE.

D5 REMOVE EXISTING ELECTRONIC SIGNAGE AND STRUCTURE.

D6 EXISTING METAL RAILINGS TO BE REMOVED, TYP.

D7 EXISTING CELLULAR/COMMUNICATION ANTENNAS TO BE REMOVED BY OTHERS PRIOR TO DEMOLITION. COORDINATE SCHEDULING OF REMOVAL WITH OWNER.

D8 REMOVE EXISTING SYSTEM IN ITS ENTIRETY.

D9 REMOVE EXISTING ROOFTOP METAL GRATING PLATFORM, STAIRS, AND ALL SUPPORTING STRUCTURE THROUGHOUT.

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NOT FOR CONSTRUCTION

WITH THE DATE AND A SPECIFIC DESCRIPTION OF EACH ALTERATION.

STATUS

REVISIONS

NO. DATE DESCRIPTION

DRAWING TITLE

STRUCTURAL DEMOLITION SECTIONS

DRAWING NUMBER

DM-302

Seal

 DATE
 04/03/2020

 SCALE
 3/32" = 1'-0"

 DRAWN BY
 B. LING

 CHECKED BY
 F. PORTUGEZ

SHEET NO. XX OF 11 24" x 36"