NEW YORK CITY ECONOMIC DEVELOPMENT CORPORATION




BELLA ABZUG PARK BLOCK 5 & 6 DEMOLITION BLOCK 710, LOT 11 533-541 W. 38TH STREET NEW YORK, NY

90% SUBMISSION

XXXX, XX, 2023

4.DR. 4.F.F.	ACCESS DOOR ABOVE FINISHED FLOOR	I.D. INCL.	INSIDE DIAMETER INCLUDING	Т. Т.&В.	TREAD TOP AND BOTTOM
4.P.	ACCESS PANEL	INFO.	INFORMATION	Т.&В. Т.&G.	TOP AND BOTTOM TONGUE AND GROOVE
ABV.	ABOVE	INSUL.	INSULATION	T.&S.	TAPE AND SPACKLE
AC.T. ADJ.	ACOUSTIC TILE ADJUSTABLE OR ADJACENT	INT.	INTERIOR	Т.О.	TOP OF
LUM.	ALUMINUM	JT.	JOINT	T.O.MAS. T.O.SL.	TOP OF MASONRY TOP OF SLAB
ANG.	ANGLE	51.	30101	T.O.S.	TOP OF STEEL
ANOD. APPD.	ANODIZED APPROVED			TAN.	TANGENT
APPROX.	APPROXIMATE	К.	KIPS	TEMP. TERM.	TEMPORARY TERMINAL
ARCH.	ARCHITECTURAL			THK.	THICK
ASTM	AMERICAN SOCIETY FOR TESTING AND MATERIALS	L.	ANGLE	TRANSF.	TRANSFORMER
	INTERNATIONAL	L.L.	LIVE LOAD	TYP.	TYPICAL
		L.P. L.W.			
3.	BASE	L.W.	LIGHT WEIGHT LAMINATED	U.L.DES.	UNDERWRITERS LABOR
3.L.		LAV.	LAVATORY	U.N.	UNLESS NOTED
BD. BKT.	BOARD BRACKET	LG.	LONG	UNIF.	
BLDG.	BUILDING	LT. LTG.	LIGHT LIGHTING	UNFIN.	UNFINISHED
BM. BOT.	BEAM BOTTOM	LIG.			
BRK.	BRICK			V.I.F.	VERIFY IN FIELD
				VERT.	VERTICAL
C.	COURSES	M.D. M.H.	METAL DECK MANHOLE		
С.Н.	CEILING HEIGHT	M.O.	MANHOLE MASONRY OPENING		
D.JT. D.L.	CONSTRUCTION JOINT CENTERLINE	MANUF.	MANUFACTURER	W/	WITH
.∟. C.M.U.	CONCRETE MASONRY UNIT	MAS.	MASONRY	W.	WIDE
C.R.	CEILING REGISTER	MAT'L.		W.P.	WORKING POINT
C.S.	CONCRETE SLAB	MAX. MECH.	MAXIMUM MECHANICAL	W.R.	WASTE RECEPTACLE
CAB. CEM.	CABINET CEMENT	MFG.	MANUFACTURER		
CER.T.	CERAMIC TILE	MIN.	MINIMUM		
CHAN.	CHANNEL	MISC.	MISCELLANEOUS		
CLG.		MTL.	METAL		
COL. CONC.	COLUMN CONCRETE				
COND.	CONDITIONS	N.	NORTH		
CONN.	CONNECTION	N.F.			
CONST. CONT.	CONSTRUCTION CONTINUOUS	NO. N.S.	NUMBER NEAR SIDE		
CONT.	CONVECTOR	N.T.S.	NOT TO SCALE		
CORR.	CORRUGATED	NY	NEW YORK		
CSK.	COUNTERSINK:SUNK				
CT CTA	CERAMIC TILE CENTRAL TERMINAL AREA	O.A.			
		0.A. 0.C.	OVER ALL ON CENTER		
).	DIAMETER	O.H.	OVER HEAD		
0.0.	DITTO	OPN'G.	OPENING		
)BL.)EPT.	DOUBLE DEPARTMENT	OPP. O.D.	OPPOSITE OUTSIDE DIAMETER		
DESCR.	DESCRIPTION	0.0.			
DET.	DETAIL				
DIA. DIFF.	DIAMETER DIFFUSER				
DIM.	DIMENSION	PART. PENETR.	PARTITION PENETRATION		
DN.	DOWN	PENETR. P.I.P.	POURED IN PLACE		
DR. DWG.		PL.	PLATE		
WG.	DRAWING	PLAS.	PLASTER		
EA.	EACH	PLUMB. P.M.	PLUMBING PREMOLDED		
EL.	ELEVATION	PNL.	PANEL		
ELEC.	ELECTRICAL	POL.	POLISHED		
ELEV. EMERG	ELEVATOR EMERGENCY CALL BOX	PREFAB.	PREFABRICATED		
ENCL.	ENCLOSURE	P.S.F. P.S.I.	POUNDS PER SQUARE FOOT POUNDS PER SQUARE INCH		
EQ.	EQUAL	PT.	PART		
EQ.SP. EQUIP.	EQUAL SPACES	PTD.	PAINTED		
TC.	EQUIPMENT ETCETRA				
EXT.	EXTERIOR				
XIST.	EXISTING	Q.T.	QUARRY TILE		
EXP.JT.	EXPANSION JOINT	G. I.			
EXPN. EXTN.	EXPANSION EXTENSION	R.D.	ROOF DRAIN		
E.W.C.	ELECTRIC WATER COOLER	RAD.	RADIUS		
		REF. REINF.	REFERENCE REINFORCED:ING:MENT		
- ^	FRESH AIR	REQ.	REQUIRED		
.A. .D.	FRESHAIR FLOOR DRAIN	RM.	ROOM		
.FLR	FINISH FLOOR	RW	RAIN WATER		
.О. .Р.	FACE OF FIRE PROOFING	SAF.	SAFETY		
DN.	FOUNDATION	S.D.	SOAP DISPENSER		
IN.	FINISHED	S.F.	SQUARE FEET		
IXT. L.	FIXTURE FLUSH	S.P. S.PT.	SEE PLAN STARTING POINT		
L. LR.	FLOOR	S.S.	STARTING POINT STAINLESS STEEL		
LT.HD.	FLAT HEAD	SDL.	SADDLE		
R.	FRAME	SECT. SHT.	SECTION		
T. TG.	FEET:FOOT FOOTING	SHT. SIM.	SHEET SIMILAR		
UT.	FUTURE				
G.R.	GUARD RAIL	SLD'G.	SLIDING		
SA.	GAUGE	SLD'G. SPEC.	SLIDING SPECIFICATION		
GALV.	GALVANIZED	SQ.	SQUARE		
GL. GR.	GLASS GRILL	ST. STIFF	STAINLESS		
GRTG.	GRATING	STIFF. STL.	STIFFENER STEEL		
STC	GROUND TRANSPORTATION CENTER	STRUCT.	STEEL		
		SUSP.	SUSPENDED		
ł.	HIGH	SYS.	SYSTEM		
I. I.M.	HIGH HOLLOW METAL				
I.P.	HIGH POINT				
I.R.	HANDRAIL				
I.S. I.V.A.C.	HIGH STRENGTH HEATING, VENTILATION &				
	AIR CONDITIONING				
ID.	HEAD				
IDR.	HEADER				
IEX. IGT.	HEXAGONAL HEIGHT				
	HORIZONTAL				
IORIZ.					

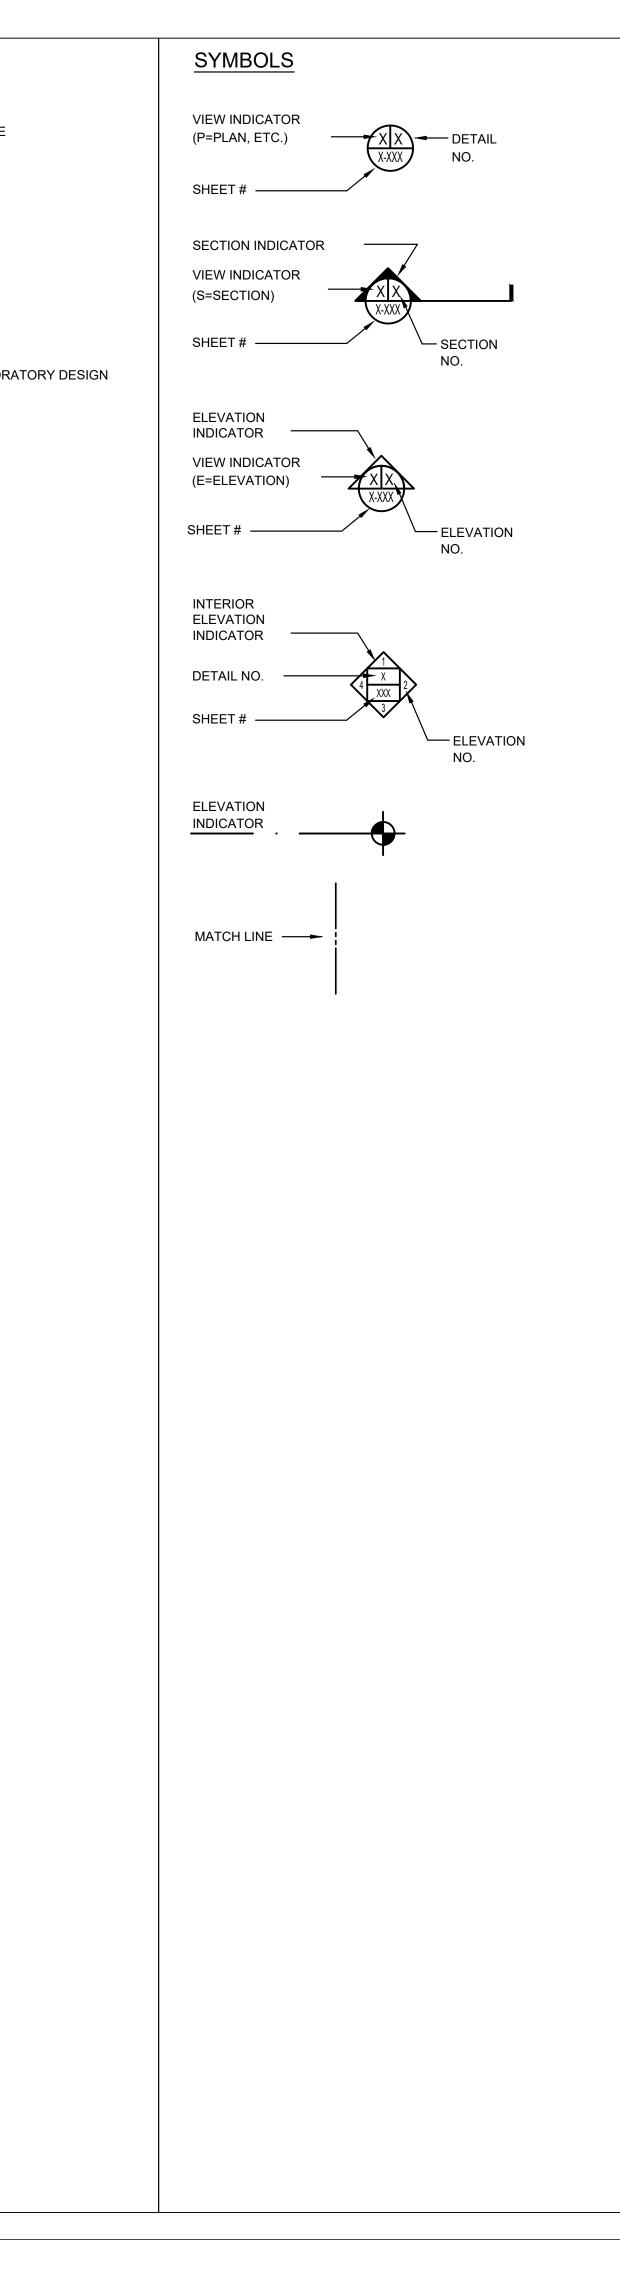

DRAWING	INDEX	
SHEET NO.	DRAWING NO.	DRAWING TITLE
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3	G-002	GENERAL DEMOLITION NOTES
4	G-003	SITE PLAN
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AERIAL LOCATION MAP G-001 / SCALE: N.T.S.

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BELLA ABZUG PARK BLOCKS 5 & 6 CLIENT GROUP Hudson Yards Development Corporation DESIGNERS **(\SI)** Tel: 212.465.5000 Fax: 212.465.5584 WARNING: IT IS A VIOLATION OF NEW YORK LAW FOR ANY PERSON, UNLESS ACTING UNDER THE DIRECTION OF A LICENSED ARCHITECT, LANDSCAPE ARCHITECT, PROFESSIONAL ENGINEER, OR LAND SURVEYOR (AS APPLICABLE) TO ALTER ANY ITEM SHOWN ON THIS DOCUMENT IN ANY WAY. IF A DOCUMENT OR ITEM BEARING THE SEAL OF ANY SUCH LICENSED PROFESSIONAL IS ALTERED, THE ALTERING ARCHITECT, LANDSCAPE ARCHITECT, PROFESSIONAL ENGINEER, OR LAND SURVEYOR SHALL AFFIX TO EACH ALTERED ITEM THEIR SEAL WITH THE NOTATION "ALTERED BY" FOLLOWED BY THEIR SIGNATURE WITH THE DATE AND A SPECIFIC DESCRIPTION OF EACH ALTERATION. **NOT FOR** CONSTRUCTION STATUS REVISIONS NO. DATE DESCRIPTION DRAWING TITLE ABBREVIATIONS, SYMBOLS AND DRAWINGS INDEX DRAWING NUMBER G-001 Seal DATE 04/03/2020 SCALE 1/8" = 1'-0" DRAWN BY D.SYROM CHECKED BY W.LEE SHEET NO. XX OF 11 24" x 36"

GENERAL NOTES:

- 1. INFORMATION PROVIDED BY CONTRACT DRAWINGS MAY NOT MATCH ACTUAL FIELD CONDITIONS. VERIFY ALL INDICATED CONDITIONS AND DIMENSIONS IN THE FIELD BEFORE COMMENCING ANY WORK. NOTIFY THE ARCHITECT OF ANY CONDITIONS OR DIMENSIONS THAT WOULD PREVENT OR HAMPER THE PERFORMANCE OF THE WORK IN ACCORDANCE WITH THE CONTRACT DRAWINGS AND SPECIFICATIONS.
- 2. THE CONTRACTOR SHALL INSPECT THE SITE AND CAREFULLY EXAMINE AND ANALYZE THE PROVISIONS AND REQUIREMENTS OF THE CONTRACT AND UNDERSTAND ALL THINGS REQUIRED FOR THE PERFORMANCE OF THIS CONTRACT. FOR BELOW GRADE STRUCTURAL ELEMENTS SUCH AS FLOOR SLAB, GRADE BEAMS, PILE CAPS, PILES, PITS, TRENCHES, ETC..
- 3. UNLESS OTHERWISE NOTED ON CONTRACT DRAWINGS, REMOVE AND DISPOSE OF THE ENTIRE BUILDING INCLUDING, BUT NOT LIMITED TO STRUCTURES, FOUNDATIONS, UNDERGROUND PITS AND TRENCHES, ELECTRICAL, PLUMBING & MECHANICAL EQUIPMENT, FINISHES AND ANY OTHER CONTENT WITHIN THE PERIMETER FENCE. REFER TO CONTRACT SPECIFICATION SECTION 02050 "DEMOLITION AND DISPOSAL" FOR ADDITIONAL DEMOLITION DESIGN AND PERFORMANCE, DEMOLITION, PROTECTION, AND POLLUTION CONTROL REQUIREMENTS.
- 4. UNLESS OTHERWISE NOTED ON CONTRACT DRAWINGS, CLEAR ALL OBSTRUCTIONS PROTRUDING FROM EXISTING GRADE INCLUDING, BUT NOT LIMITED TO SIDEWALK, CURBS, GUARDRAILS, TRAFFIC SIGNS, CONCRETE PADS, EXTERIOR STAIRCASES, PLATFORMS, RAILINGS AND THEIR ASSOCIATED FOUNDATION.
- 5. FREE ACCESS TO FIRE HYDRANTS AND TO OUTSIDE CONNECTIONS FOR STANDPIPES, SPRINKLERS, OR OTHER FIRE EXTINGUISHING EQUIPMENT, WHETHER PERMANENT OR TEMPORARY SHALL BE PROVIDED AND MAINTAINED AT ALL TIMES.
- 6. NO MATERIAL, EQUIPMENT OR CONSTRUCTION SHALL INTERFERE WITH ACCESS TO HYDRANTS, SIAMESE CONNECTIONS OR FIRE EXTINGUISHING EQUIPMENT.
- 7. FOR RECYCLING OF DESIGNATED DEBRIS MATERIAL, SEE SPECIFICATION SECTION 02050.
- 8. STOCKPILES OF DEBRIS AND SOIL SHALL BE SECURED AND LOCATED WITHIN PERIMETER FENCE. STOCKPILES SHALL BE NO HIGHER THAN EIGHT FEET IN HEIGHT. SEE CIVIL DRAWINGS FOR PERIMETER FENCE LOCATION. SPRAY WATER TO WET DOWN STOCKPILES FOR DUST CONTROL. MATERIALS CAPABLE OF CREATING FOREIGN OBJECT DEBRIS MUST BE CONTINUOUSLY REMOVED DURING CONSTRUCTION.
- 9. STOCKPILES OF DEBRIS FOR EXISTING FOUNDATION ELEMENTS, INCLUDING REINFORCED CONCRETE, GROUND FLOOR SLABS, UNDERGROUND PILE CAPS, PILES, UNDERGROUND GRADE BEAMS, UNDERGROUND TRENCHES AND UNDERGROUND PITS SHALL BE CLEARLY SEPARATED FROM OTHER CONSTRUCTION DEBRIS STOCKPILES. MATERIALS SHOULD BE TESTED FOR CONTAMINATION AND IF POSITIVE, DISPOSED OF AS REQUIRED BY LOCAL JURISDICTIONS.
- 10. PROVIDE ONE TRAINED SITE SECURITY GUARD AT THE CONSTRUCTION ACCESS GATE IN ACCORDANCE WITH NFPA 241 SITE SECURITY GUARD REQUIREMENTS. THE GUARD(S) SHALL BE ON DUTY DURING ALL HOURS, BOTH WHEN OPERATIONS ARE IN PROGRESS AND WHEN OPERATIONS ARE NOT IN PROGRESS.
- 11. ASSIGN WATCHPERSON AND FLAGPERSON IN ACCORDANCE WITH NYCBC 3307.5 REQUIREMENTS.
- 12. PEDESTRIANS SHALL BE PROTECTED DURING ALL CONSTRUCTION AND DEMOLITION ACTIVITIES. FURNISH, INSTALL AND MAINTAIN FENCE AND SIDEWALK SHED (IF REQUIRED) ALONG SIDEWALK DURING DEMOLITION IN ACCORDANCE WITH NYC BUILDING CODE. DESIGN FENCE, SIDEWALK SHED AND ITS LIGHTING SYSTEM ACCORDING TO NYC BUILDING CODE BY PROFESSIONAL ENGINEERS LICENSED IN NEW YORK. CLOSE SIDEWALK TEMPORARILY AS REQUIRED FOR EXTERIOR BUILDING DEMOLITION WORK WHERE PEDESTRIANS COULD NOT BE PROTECTED SUCH AS AT AREA NEAR CONSTRUCTION ENTRANCE GATE. SIDEWALK SHED LIGHTS SHOULD BE POWERED FROM CONTRACTORS TEMPORARY POWER. SIDEWALK SHED AREA NEAR CONSTRUCTION ENTRANCE GATE. SIDEWALK SHED LIGHTS SHOULD BE POWERED FROM CONTRACTORS TEMPORARY POWER. SIDEWALK SHED AREA NEAR CONSTRUCTION ENTRANCE GATE. SIDEWALK SHED LIGHTS SHOULD BE POWERED FROM CONTRACTORS TEMPORARY POWER. SIDEWALK SHED SHALL NOT BE CONSTRUCTED SO THAT IT IMPEDES ACCESS TO HYDRANTS.
- 13. TAKE ALL NECESSARY PRECAUTIONS TO PROTECT ALL EXISTING UTILITIES THAT ARE TO REMAIN. ANY UTILITIES DAMAGED BY THE CONTRACTOR SHALL BE REPAIRED OR REPLACED IMMEDIATELY AT NO ADDITIONAL COST, DESIGNED BY NY STATE LICENSED PROFESSIONAL ENGINEER. ALL DEMOLITION SHALL BE ON HOLD UNTIL THE REPAIR OR REPLACEMENT WORKS HAVE BEEN COMPLETED, AND TO THE SATISFACTION OF THE ENGINEER. CUTTING AND CAPPING OF UTILITIES WILL BE BY OTHERS.
- 14. TAKE ALL NECESSARY PRECAUTIONS TO ENSURE NO DEBRIS OR FOREIGN OBJECT DEBRIS PROJECT BEYOND THE SAFE WORK ZONE PERIMETER ESTABLISHED BY THE CONTRACTOR. AT ALL TIMES FURNISH AND INSTALL TEMPORARY SOLID FENCING, OTHER THAN PERIMETER FENCE, TO CONTAIN DEBRIS OR FOREIGN OBJECT DEBRIS THAT COULD BE PROJECTED AND/OR BE CARRIED BY WIND INTO ADJACENT AREAS.
- REFER TO SPECIFICATIONS FOR REQUIREMENTS OF ALL TEMPORARY PROTECTIONS AND SHORING DESIGN DRAWINGS AND CALCULATIONS.
- 16. THE LOCATION, ELEVATION AND SIZE OF EXISTING UTILITIES SHOWN ON THE CONTRACT DRAWINGS ARE APPROXIMATE. THE FOLLOWING SHALL BE PERFORMED:
- A. VERIFY THE LOCATION OF EXISTING UNDERGROUND UTILITIES WITHIN THE WORK AREA PRIOR TO DEMOLITION.
- B. EXERCISE EXTREME CAUTION, INCLUDING HAND EXCAVATION, TO EXPOSE LINES WHEN WORK IS ADJACENT TO EXISTING POWER, COMMUNICATIONS, WATER AND GAS LINES TO PREVENT DAMAGE TO THESE LINES.
- C. IMMEDIATELY REPAIR ANY DAMAGE TO EXISTING UTILITIES CAUSED BY THE CONTRACTOR IN A MANNER APPROVED BY THE ENGINEER, AT NO ADDITIONAL COST TO THE OWNER.
- 17. ALLOW TIME FOR THE CM TO PERFORM FIELD SURVEY ON THE LOCATION OF ALL EXISTING PILES, USING CENTER POINT AT TOP OF EACH PILE AS REFERENCE POINT, PRIOR TO SOIL BACKFILL. REFER TO SPECIFICATIONS FOR SUBMTTAL REQUIREMENTS.
- 18. PREVENT WATER PONDING FROM CONTRACTOR'S OPERATIONS. PROMPTLY REMOVE ANY PONDING WATER TO THE SATISFACTION OF THE ENGINEER.
- 19. IT IS ASSUMED THAT ALL STRUCTURAL STEEL IS COATED WITH LEAD CONTAINING PAINT. LEAD CONTAINING PAINT MUST BE REMOVED 4 INCHES ON EACH SIDE OF THE CENTERLINE OF CUT, BOLT ROW, OR WELD FROM STRUCTURAL STEEL PRIOR TO ANY HEATING, WELDING, FLAME CUTTING, OR SAW CUTTING. REFER TO SPECIFICATIONS FOR PROPER ABATEMENT PROCEDURES.
- 20. CONTRACTOR SHOULD CONFORM TO THE FOLLOWING CODES. STANDARDS, AND SPECIAL INSPECTIONS THROUGHOUT THE DEMOLITION: 2014 NYC BUILDING CODE, 2014 NYC FIRE CODE, AND NYC BUILDING CODE BC 1704.20
- 21. MAINTAIN SECURITY FENCING AT ALL TIMES.
- 22. ALL EROSION AND SEDIMENT CONTROL DEVICES SHALL BE COMPLETED PRIOR TO COMMENCEMENT OF DEMOLITION.
- 23. HORIZONTAL CONTROL POINTS: ALL BEARINGS AND COORDINATES ARE BASED ON NORTH AMERICAN DATUM OF 1983 (NAD83/2007) AND NEW YORK STATE PLANE COORDINATE SYSTEM LONG ISLAND (NYSPES LI).
- 24. VERTICAL CONTROL POINTS: ALL VERTICAL ELEVATIONS AND CONTOURS ARE IN FEET AND REFER TO THE NORTH AMERICAN VERTICAL DATUM OF 1988 (NAVD88).

STRUCTURAL NOTES:

- 1. VERIFY ALL DIMENSIONS AND CONDITIONS OF EXISTING STRUCTURES CONTROLLING NEW CONSTRUCTION IN THE FIELD. PREPARE SHOP DRAWINGS BASED ON THE ACTUAL FIELD CONDITIONS.
- 2. ANY PORTION OF EXISTING WORK WHICH IS TO REMAIN THAT IS DISTURBED OR DAMAGED IN THE COURSE OF DEMOLITION SHALL BE RESTORED TO A CONDITION AS GOOD AS THAT EXISTING BEFORE THE COMMENCEMENT OF THE WORK.
- 3. ELEVATIONS INDICATED ON ALL DEMOLITION DRAWINGS BASED ON NAVD88. ELEVATIONS SHOWN ON ALL REFERENCE DRAWINGS BASED ON NGVD29. TO CONVERT THE REFERENCE DRAWING ELEVATIONS FROM NGVD29 TO NAVD88, SUBTRACT 3.2 FEET FROM THE REFERENCE DRAWING ELEVATIONS.
- 4. MAINTAIN AND PROTECT EXISTING UTILITIES THAT MUST REMAIN IN SERVICE AND EQUIPMENT. NOTIFY THE ENGINEER 48 HOURS IN ADVANCE OF ANY WORK ON OR IN THE VICINITY OF ANY DUCT LINES. USE HAND EXCAVATION TO DETERMINE THE EXACT LOCATION OF ALL UTILITIES. INSULATE ALL CONSTRUCTION EQUIPMENT TO AVOID ACCIDENTAL GROUNDING.
- 5. REFER TO SPECIFICATIONS FOR SUBMITTAL REQUIREMENTS FOR ALL TEMPORARY CONSTRUCTION STRUCTURES USED FOR SHORING, BRACING AND SUPPORT.
- 6. QUALIFIED PERSONNEL, AS DEFINED IN NYCBC SECTION 3302, SHALL BE USED FOR REMOVAL AND DEMOLITION OPERATIONS. REMOVAL AND DEMOLITION OPERATIONS SHALL BE PERFORMED IN A CAREFUL AND CONTROLLED MANNER TO AVOID HAZARDS TO PERSONS, DAMAGE TO PROPERTY AND ANY SPREADING OF DUST AND FLYING PARTICLES.
- 7. NO PORTIONS OF THE REMOVAL SHALL BE PERMITTED TO FALL NOR SHALL ANY DEBRIS BE DROPPED. PROPER METHODS SHALL BE USED TO ENSURE LIFE SAFETY AND INTEGRITY OF THE EXISTING STRUCTURE.
- 8. ASBESTOS ABATEMENT AND HAZARDOUS MATERIALS REMEDIATION SHALL BE COMPLETED PRIOR TO COMMENCEMENT OF STRUCTURAL DEMOLITION.

MECHANICAL NOTES:

HVAC DEMOLITION NOTES:

- 1. PRIOR TO REMOVAL OF MECHANICAL EQUIPMENT, DISCONNECT PIPING AND ENSURE ELECTRICAL POWER SUPPLY HAS BEEN DISCONNECTED.
- 2. PRIOR TO REMOVAL OF ALL WATER AND OIL PIPING, DRAIN THE PIPING AND DISPOSE WATER AND OIL IN ACCORDANCE WITH APPLICABLE ENVIRONMENTAL REGULATIONS.
- 3. REMOVE AND RECOVER ALL REFRIGERANTS FROM ALL REFRIGERATION EQUIPMENT AND PIPING PRIOR TO COMMENCING ANY EQUIPMENT AND/OR BUILDING DEMOLITION. DISCONNECT AND REMOVE ALL REFRIGERATION EQUIPMENT INCLUDING PIPING, ELECTRICAL POWER SUPPLY AND AUXILIARY EQUIPMENT PRIOR TO BUILDING DEMOLITION.
- 4. REMOVE ALL HVAC EQUIPMENT INCLUDING, BUT NOT LIMITED TO, SUPPLY AIR FANS, VENTILATING UNITS, FANS, DUCTWORK, FLUES, PUMPS, PIPING, ELECTRICAL POWER SUPPLY AND CONTROLS PRIOR TO BUILDING DEMOLITION.

ELEVATOR DEMOLITION NOTES:

- 1. ELEVATOR SHALL BE POSITIONED AT THE LOWEST LEVEL PRIOR TO ELECTRICITY SHUT DOWN.
- 2. DISCONNECT, DISMANTLE AND REMOVE THE ELEVATOR CAB AND ELECTRICAL AND HYDRAULIC EQUIPMENT AND APPURTENANCES, INCLUDING PIPING, ELECTRICAL POWER SUPPLY, TANK, MOTORS, CONTROLS, SUPPORTS, ETC.
- 3. PRIOR TO HYDRAULIC FLUID REMOVAL, DRAIN THE PIPING AND DISPOSE HYDRAULIC FLUID IN ACCORDANCE WITH APPLICABLE ENVIRONMENTAL REGULATIONS.
- 4. ELEVATORS BEING PERMANENTLY REMOVED FROM SERVICE (DISMANTLED) SHALL FOLLOW APPLICABLE ASME CODE A17.1-2000 WITH SUPPLEMENTS A17.1a-2002, AND A17.b-2003, AND NYC BUILDING CODE (INCLUDING APPENDIX K-SECTION 8.11.1.4, ELEVATORS PLACED OUT OF SERVICE (DISMANTLED). AN ELEVATOR INSPECTION WILL BE REQUIRED PER NYC BUILDING CODE 8.11.1.4.

FIRE PROTECTION DEMOLITION NOTES:

- 1. DETERMINE MEANS AND METHODS FOR FULL DEMOLITION OF ALL PLUMBING AND FIRE PROTECTION SYSTEMS. COORDINATE PLUMBING AND FIRE PROTECTION DEMOLITION WORK WITH THE CONSTRUCTION PHASING PLAN SHOWN ON VOLUME 3 AND IN THE SPECIFICATIONS.
- 2. PROVIDE THE ENGINEER 48 HOURS ADVANCE NOTICE OF THE INTENTION TO START FIELD WORK AT THE CONSTRUCTION SITE. WORK SHALL NOT BE STARTED UNTIL ALL NECESSARY EQUIPMENT AND MATERIALS ARE AT THE SITE.
- 3. PERFORM ALL CUTTING, DISASSEMBLY, TRANSPORTING, RIGGING, STAGING OF REMOVALS, REMOVAL AND DISPOSAL OF EXISTING EQUIPMENT, ASSOCIATED PIPING AND APPURTENANCES NECESSARY TO COMPLETE THE WORK OF THIS CONTRACT.
- 4. FIRE PROTECTION STANDPIPE SYSTEM: EXISTING STANDPIPE IS TO BE ENERGIZED AND FILLED PRIOR TO DEMOLITION START. ALL STANDPIPES ARE TO BE ACTIVE, WITH THE EXCEPTION OF WHEN THEY ARE BEING DEMOLISHED, THROUGHOUT THE DEMOLITION. STAND PIPES IN EXISTING STAIR TOWERS SHALL ALSO CONFORM TO THIS REQUIREMENT.

PLUMBING DEMOLITION NOTES

- 1. PRIOR TO DISCONNECTING AND REMOVAL OF EXISTING PLUMBING FIXTURES AND PIPING, ENSURE THAT WATER SUPPLY HAS BEEN DISCONNECTED FROM THE MAIN WATER SERVICE.
- 2. READ AND RECORD EXISTING DOMESTIC WATER METER READING BEFORE REMOVING. SUBMIT A TABULATION WITH METER READING TO THE ENGINEER. ALL EXISTING DOMESTIC WATER METERS SHALL BE RETURNED TO THE ENGINEER.
- 3. PLUMBING PIPING BELOW GRADE MAY BE ABANDONED IN PLACE.

DEMOLITION NOTES

- 1.
 THE GENERAL CONTRACTOR IS RESPONSIBLE FOR BECOMING FAMILIAR WITH
THE BUILDING RULES AND REGULATIONS BEFORE AND DURING THE COURSE
OF CONSTRUCTION. SHOULD A CONFLICT ARISE BETWEEN THE CONTRACT
DOCUMENTS AND THE BUILDING RULES, THE CONTRACTOR IS TO NOTIFY THE
OWNER'S REPRESENTATIVE IMMEDIATELY. BUILDING RULES AND
REGULATIONS SHALL GOVERN EXCEPT WHERE THEY ARE IN CONFLICT WITH
APPLICABLE CODES AND ORDINANCES.
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- 2. GENERAL CONTRACTOR IS TO COORDINATE ALL PHASES OF DEMOLITION FOR PROJECT AND NOTIFY THE OWNER'S REPRESENTATIVE OF ANY DISCREPANCIES OR CONFLICTING CONDITIONS WHICH WOULD INTERFERE WITH THE SATISFACTORY COMPLETION OF THE WORK PRIOR TO THE START OF CONSTRUCTION.
- 3. GENERAL CONTRACTOR IS RESPONSIBLE TO PROTECT ANY EXISTING ITEMS TO REMAIN THROUGHOUT THE COURSE OF DEMOLITION.
- 4. DEMOLITION SHALL BE DONE IN NEAT WORKMAN LIKE MANNER WITHIN THE LIMITS INDICATED IN THE DRAWINGS AND IN ALL CASES TO THE EXTENT NEEDED TO PRODUCE THE INTENDED WORK.
- 5. <u>DEBRIS REMOVAL:</u> THE CONTRACTOR IS RESPONSIBLE FOR DEMOLITION AND REMOVAL OF ALL DEBRIS AND DISCARDED AND/OR EQUIPMENT AS INDICATED WITHIN THE SPACE.
- A. THE CONTRACTOR IS RESPONSIBLE FOR REMOVAL OF MATERIALS FROM THE BUILDING PREMISES ON A DAILY BASIS. DO NOT MIX DEMOLITION DEBRIS WITH THAT OF BUILDING OCCUPANTS.

6. <u>NOISE:</u>

ALL MAJOR DEMOLITION AND NOISE CREATING WORK SHALL OCCUR UNDER THE HOURS PER THE OWNER'S RULES AND REGULATIONS. NO WORK THAT GENERATES EXCESSIVE NOISE TO BE PERFORMED BEFORE 8AM. .

- PROTECTION: A. THE CONTRACTOR IS TO CONFIRM WITH THE OWNER BEFORE THE START OF DEMOLITION WHICH ITEMS ARE TO BE SAVED FROM DEMOLITION. THE OWNER TO DIRECT THE CONTRACTOR TO EITHER PROTECT THESE ITEMS OR REMOVE TO STORAGE.
- B. THE CONTRACTOR IS TO CONFIRM WITH THE OWNER BEFORE THE START OF DEMOLITION OF WHICH ITEMS INDICATED ON THE DRAWINGS ARE DEEMED TO BE NOT REQUIRED BY THE CLIENT AND ARE TO BE REMOVED FROM THE SITE.
- C. THE CONTRACTOR IS RESPONSIBLE TO PROTECT ALL EXISTING ITEMS TO REMAIN (I.E. WINDOWS, DOORS, ETC.) THROUGHOUT THE COURSE OF DEMOLITION AND CONSTRUCTION.
- D. THE CONTRACTOR MUST PROVIDE ALL REQUIRED PROTECTION TO ALL SURROUNDING AREAS THROUGHOUT THE COURSE OF DEMOLITION AND CONSTRUCTION. THERE IS TO BE NO DUST INFILTRATION BETWEEN EXISTING OCCUPIED AND CONSTRUCTION AREAS.

3. <u>REPAIR/DAMAGES:</u>

THE CONTRACTOR IS RESPONSIBLE TO REPAIR AND/OR REPLACE ANY DAMAGES IN THE SURROUNDING AREAS AND IN THE AREA OF WORK CAUSED BY DEMOLITION AND CONSTRUCTION PERFORMED IN THE AREA OF WORK.

- A. THE CONTRACTOR SHALL BE RESPONSIBLE FOR ANY LOSSES INCURRED IN THE EVENT THAT THE LOSS OF ANY SERVICES PREVENTS THE OWNER FROM CONDUCTING BUSINESS.
- B. ALL DEMOLITION WORK SHALL BE COORDINATED WITH HAZMAT WORK.
- C. CONTRACTOR TO PROVIDE TEMPORARY FIRE EXTINGUISHERS AS REQUIRED THROUGHOUT THE COURSE OF CONSTRUCTION.
- P. <u>REUSE OF MATERIALS:</u> CONTRACTOR TO REMOVE FROM SITE ALL ITEMS DEEMED NOT REUSABLE BY THE OWNER, GENERAL CONTRACTOR TO COORDINATE REUSE OF MATERIAL WITH THE OWNER.

10. <u>FURNITURE:</u>

ALL FURNITURE AND SYSTEM FURNITURE IN THE AREA OF WORK SHALL BE REMOVED PRIOR TO DEMOLITION WORK. COORDINATE WITH OWNER.

11. ALL REMOVALS OF EXISTING CABLING IN GENERAL TO BE DEMOLISHED SHOULD BE COORDINATED WITH THE OWNER.

12. TEMPORARY POWER AND LIGHTING:

PROVIDE THROUGHOUT COURSE OF DEMOLITION WHERE REQUIRED. TEMPORARY LIGHTING TO REMAIN ON JOB SITE UNTIL DEMO IS COMPLETED.

13. THE CONTRACTOR SHALL PROBE ALL WIRES/CABLES PRIOR TO REMOVAL TO INSURE THAT NO OPERATIONS ARE INADVERTENTLY INTERRUPTED. CONFIRM WIRE IS NON-ASBESTOS WITH THE OWNER PRIOR TO REMOVAL.

14. RAIL AND TRANSIT NOTE

THE WORK PROPOSED BY THIS DESIGN WILL NOT IMPACT ANY AMTRAK OR NYC TRANSIT RAIL INFRASTRUCTURE.

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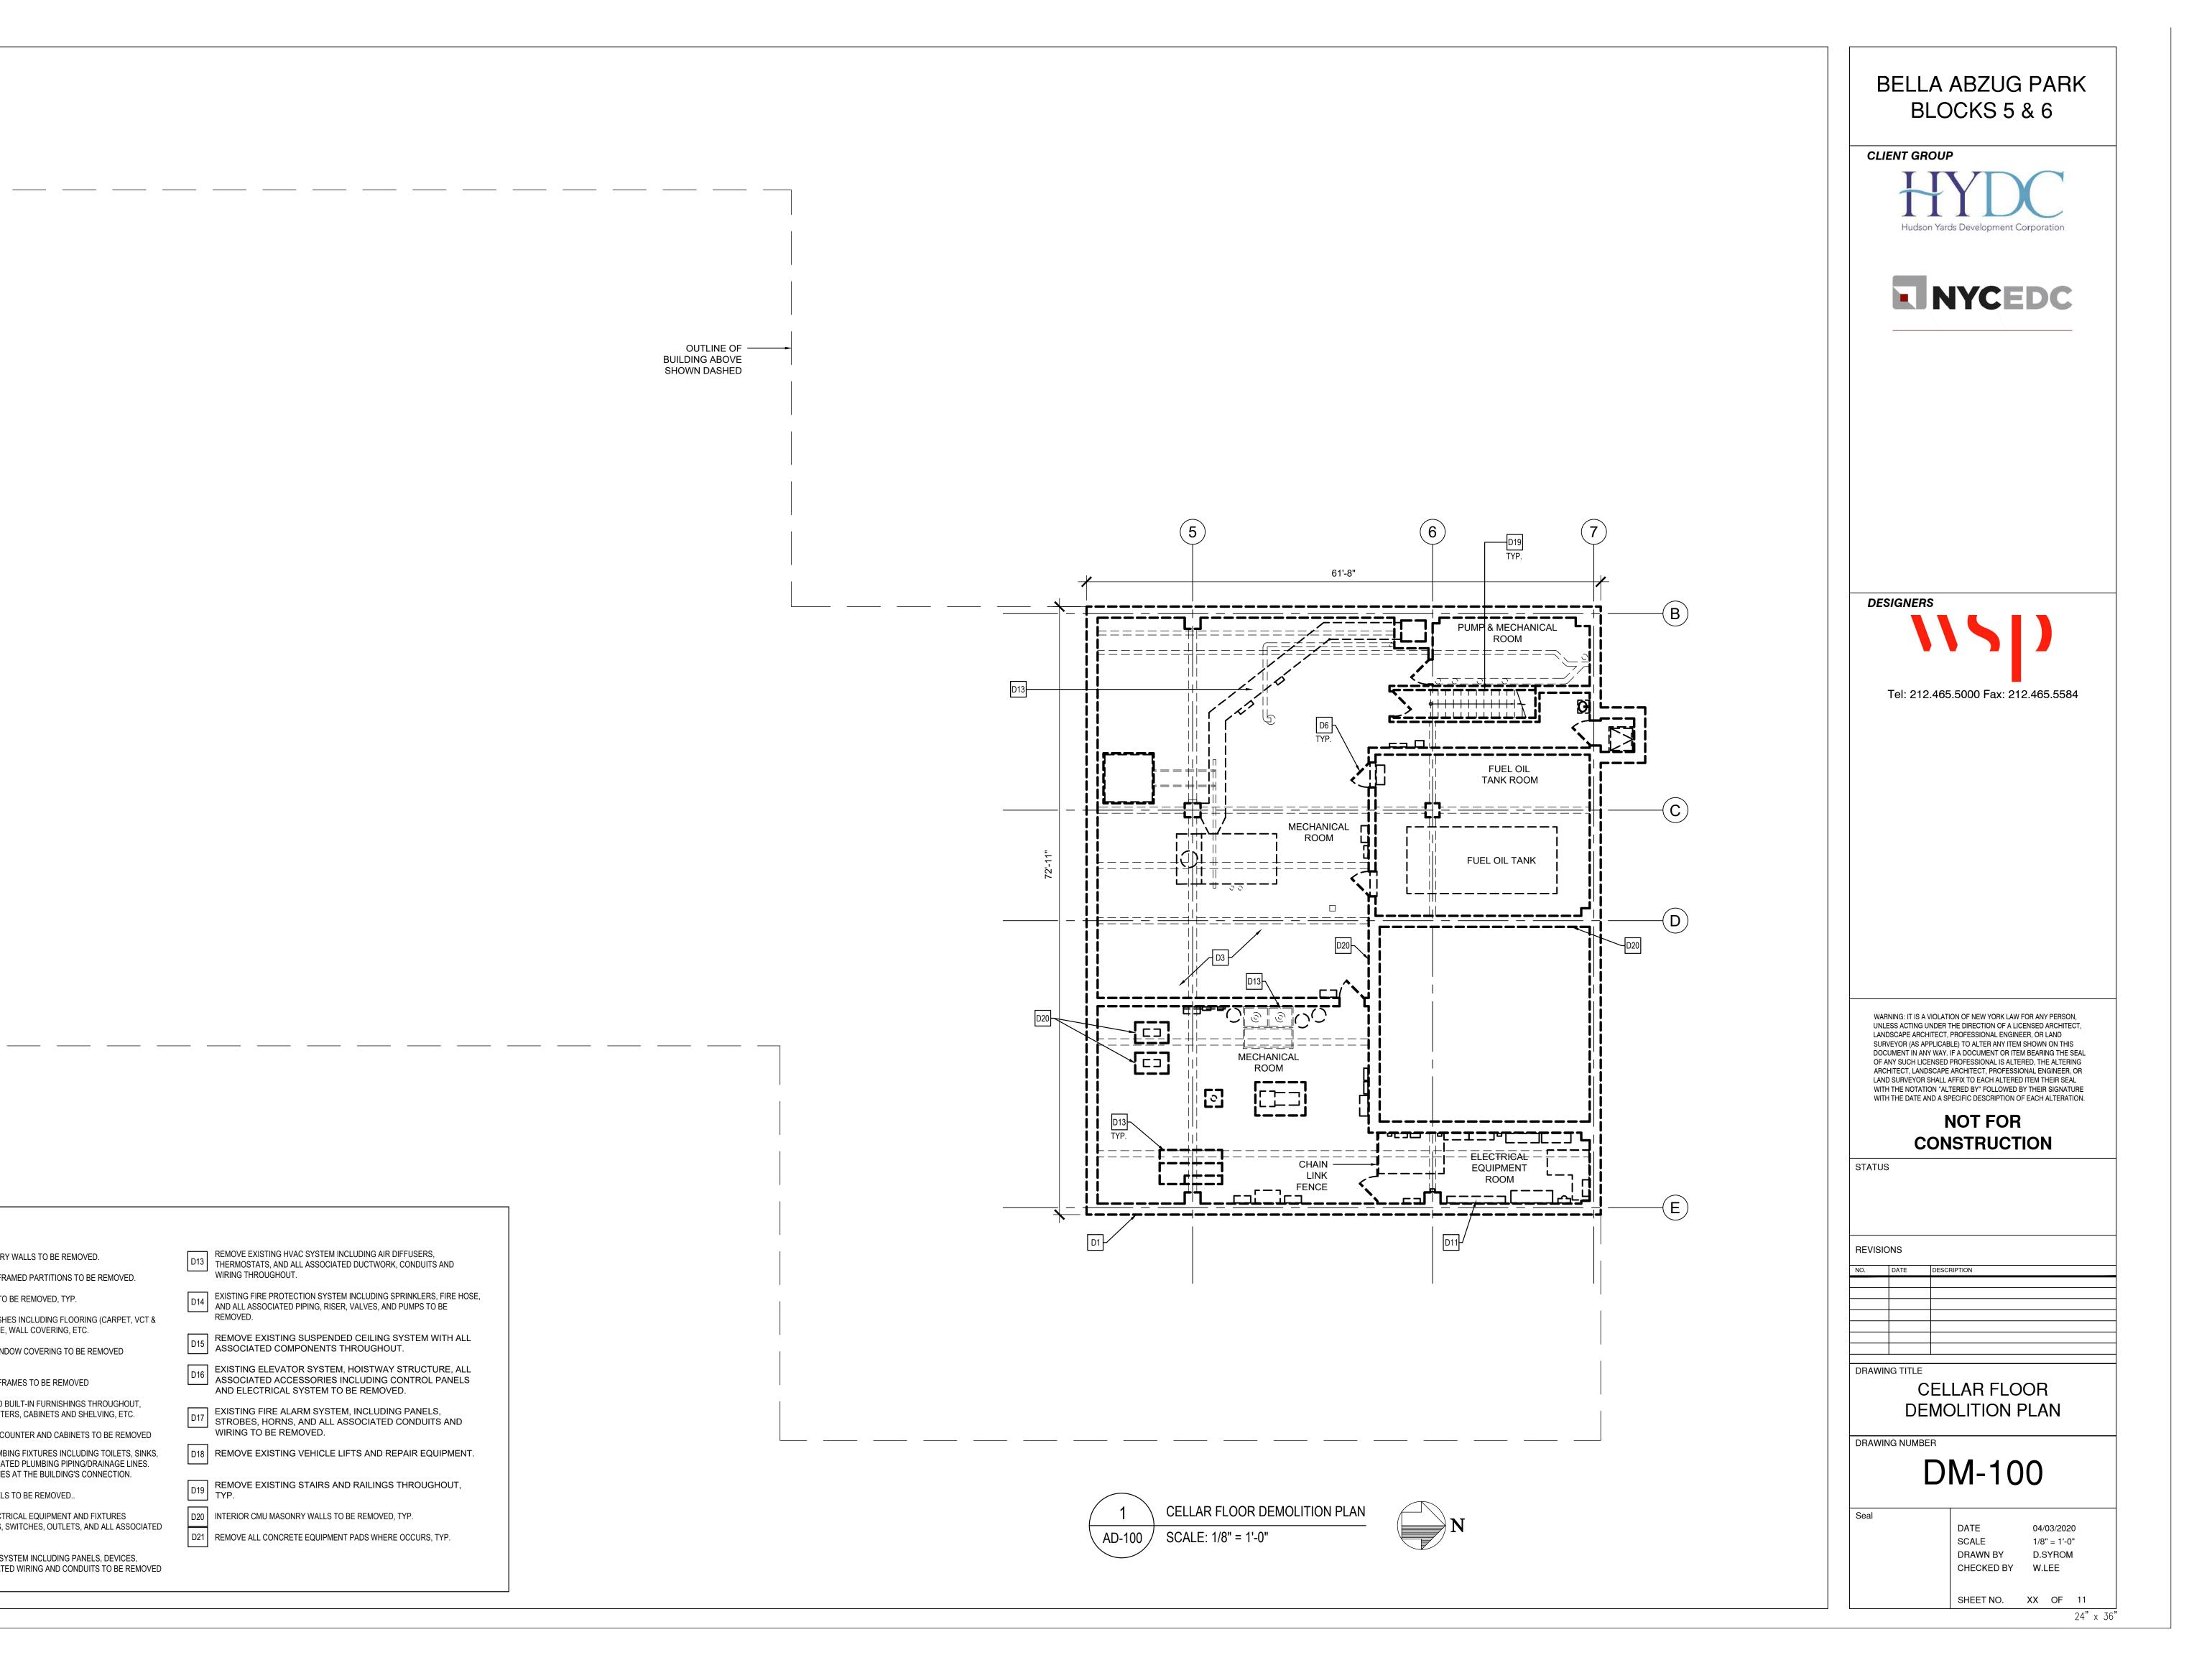
- SAFETY DURING CONSTRUCTION AND DEMOLITION SHALL COMPLY WITH NEW YORK CITY BUILDING CODE.
- THE CONTRACT DOCUMENTS DO NOT INCLUDE NECESSARY COMPONENTS FOR CONSTRUCTION SAFETY. THE CONTRACTOR HAS FULL RESPONSIBILITY FOR THE CONSTRUCTION PROCESS, SITE CONDITIONS, OPERATIONS, EQUIPMENT AND PERSONNEL, THE MAINTENANCE OF A SAFE WORKING ENVIRONMENT, AND SAFETY IN OR AROUND THE SITE OF WORK, AS MAINTAINED BY THE OCCUPATIONAL SAFETY AND HEALTH HAZARDS ASSOCIATION (OSHA) GUIDELINES.
- THE CONTRACTOR IS SOLELY RESPONSIBLE FOR ALL SHORING, BRACING, ENCLOSURES, BARRIERS, SCAFFOLDING, ETC. AS REQUIRED TO PROVIDE A SAFE WORKING ENVIRONMENT AS DICTATED BY SITE CONDITIONS OR THE PROGRESS OF WORK, PROPERTY BELONGING TO THE OWNER SHALL BE PROTECTED THROUGHOUT THE WORK.
- THE CONTRACTOR SHALL SAFE OFF AREA AND SHALL HAVE SOLE RESPONSIBILITY FOR PROTECTING ALL DANGEROUS AREAS FROM ENTRY BY UNAUTHORIZED PARTIES.
- IN ACCORDANCE WITH STANDARD CODE REGULATIONS, A SAFETY BARRIER MUST BE ERECTED AROUND THE CONSTRUCTION AREAS FACING AREAS OF PEDESTRIAN TRAFFIC. COMPLY WITH OWNER APPROVED STANDARDS FOR BARRIER CONSTRUCTION AND/OR ALL AUTHORITIES HAVING JURISDICTION.
- COMPLETE PROTECTION SHALL BE GIVEN TO ALL OWNER'S EQUIPMENT. THE ENTIRE CONSTRUCTION SITE SHALL BE SEPARATED FROM ADJACENT BUILDING AREAS BY MEANS OF A BARRIER OVER THE EXISTING FACADE. ALL ADJACENT AREAS SHALL BE KEPT FREE OF DUST AND CONSTRUCTION DEBRIS.
- FIRE EXITS SHALL BE KEPT READILY ACCESSIBLE AND UNRESTRICTED AT ALL TIMES.
- BUILDING MATERIALS, TOOLS AND EQUIPMENT SHALL BE STORED WITHIN THE PREMISES AS APPROVED BY THE OWNER. AT NO TIME SHALL SUCH ITEMS BE STORED IN OPEN AREAS INCLUDING CORRIDORS OR STAIR WELLS.
- SUBMIT TO THE OWNER FOR REVIEW A SITE SAFETY PLAN(S) PREPARED AND SIGNED BY A NEW YORK STATE LICENSED SITE SAFETY MANAGER. THE PLAN(S) SHALL BE COMPLETE, REFLECTING THE ENTIRE SITE AND SHALL SHOW ANY PHASED PROTECTION.
- THE SITE SAFETY PLAN(S) SHALL INCLUDE, BUT SHALL NOT BE LIMITED TO NOTES, SIDEWALK BRIDGES, FENCES, EGRESS, SCAFFOLDING, FIRE PROTECTION, ETC. THEY SHOULD BE ADDRESS ANY POTENTIAL INTERACTION BETWEEN THE BUILDING OCCUPANTS AND GENERAL PUBLIC AND EXPOSURE TO THE CONSTRUCTION PROCESS.
- SEE SPECIFICATIONS GENERAL AND SPECIAL CONDITIONS FOR DETAILS.
 NO WORK IS TO PROCEED UNTIL SITE SAFETY PLANS ARE APPROVED BY THE OWNER.







D1	EXISTING EXTERIOR MASONRY WALLS TO BE REMOVED.
D2	EXISTING INTERIOR METAL FRAMED PARTITIONS TO BE REMOVED.
D3	EXISTING CONCRETE SLAB TO BE REMOVED, TYP.
D4	REMOVE ALL INTERIOR FINISHES INCLUDING FLOORING (CARPET, VCT & PORCELAIN TILE), WALL BASE, WALL COVERING, ETC.
D5	EXISTING WINDOWS AND WINDOW COVERING TO BE REMOVED THROUGHOUT.
D6	EXISTING H.M. DOORS AND FRAMES TO BE REMOVED
D7	REMOVE ALL MILLWORK AND BUILT-IN FURNISHINGS THROUGHOUT, INCLUDING BENCHES, COUNTERS, CABINETS AND SHELVING, ETC.
D8	EXISTING KITCHEN PANTRY COUNTER AND CABINETS TO BE REMOVED
D9	REMOVE ALL EXISTING PLUMBING FIXTURES INCLUDING TOILETS, SINKS, BATHTUBS, AND ALL ASSOCIATED PLUMBING PIPING/DRAINAGE LINES. CUT AND CAP PLUMBING LINES AT THE BUILDING'S CONNECTION.
D10	EXISTING ELECTRICAL PANELS TO BE REMOVED
D11	REMOVE ALL EXISTING ELECTRICAL EQUIPMENT AND FIXTURES INCLUDING LIGHT FIXTURES, SWITCHES, OUTLETS, AND ALL ASSOCIATED CONDUITS AND WIRING.
D12	EXISTING COMMUNICATION SYSTEM INCLUDING PANELS, DEVICES, OUTLETS, AND ALL ASSOCIATED WIRING AND CONDUITS TO BE REMOVED THROUGHOUT.


D13	REMOVE EXISTING HVAC SYSTEM INCLUDING AIR DIFFUSERS, THERMOSTATS, AND ALL ASSOCIATED DUCTWORK, CONDUITS AND WIRING THROUGHOUT.
D14	EXISTING FIRE PROTECTION SYSTEM INCLUDING SPRINKLERS, FIRE HOSE, AND ALL ASSOCIATED PIPING, RISER, VALVES, AND PUMPS TO BE REMOVED.
D15	REMOVE EXISTING SUSPENDED CEILING SYSTEM WITH ALL ASSOCIATED COMPONENTS THROUGHOUT.
D16	EXISTING ELEVATOR SYSTEM, HOISTWAY STRUCTURE, ALL ASSOCIATED ACCESSORIES INCLUDING CONTROL PANELS AND ELECTRICAL SYSTEM TO BE REMOVED.
D17	EXISTING FIRE ALARM SYSTEM, INCLUDING PANELS, STROBES, HORNS, AND ALL ASSOCIATED CONDUITS AND WIRING TO BE REMOVED.
D18	REMOVE EXISTING VEHICLE LIFTS AND REPAIR EQUIPMENT.
D19	REMOVE EXISTING STAIRS AND RAILINGS THROUGHOUT, TYP.
D20	INTERIOR CMU MASONRY WALLS TO BE REMOVED, TYP.
D21	REMOVE ALL CONCRETE EQUIPMENT PADS WHERE OCCURS, TYP.




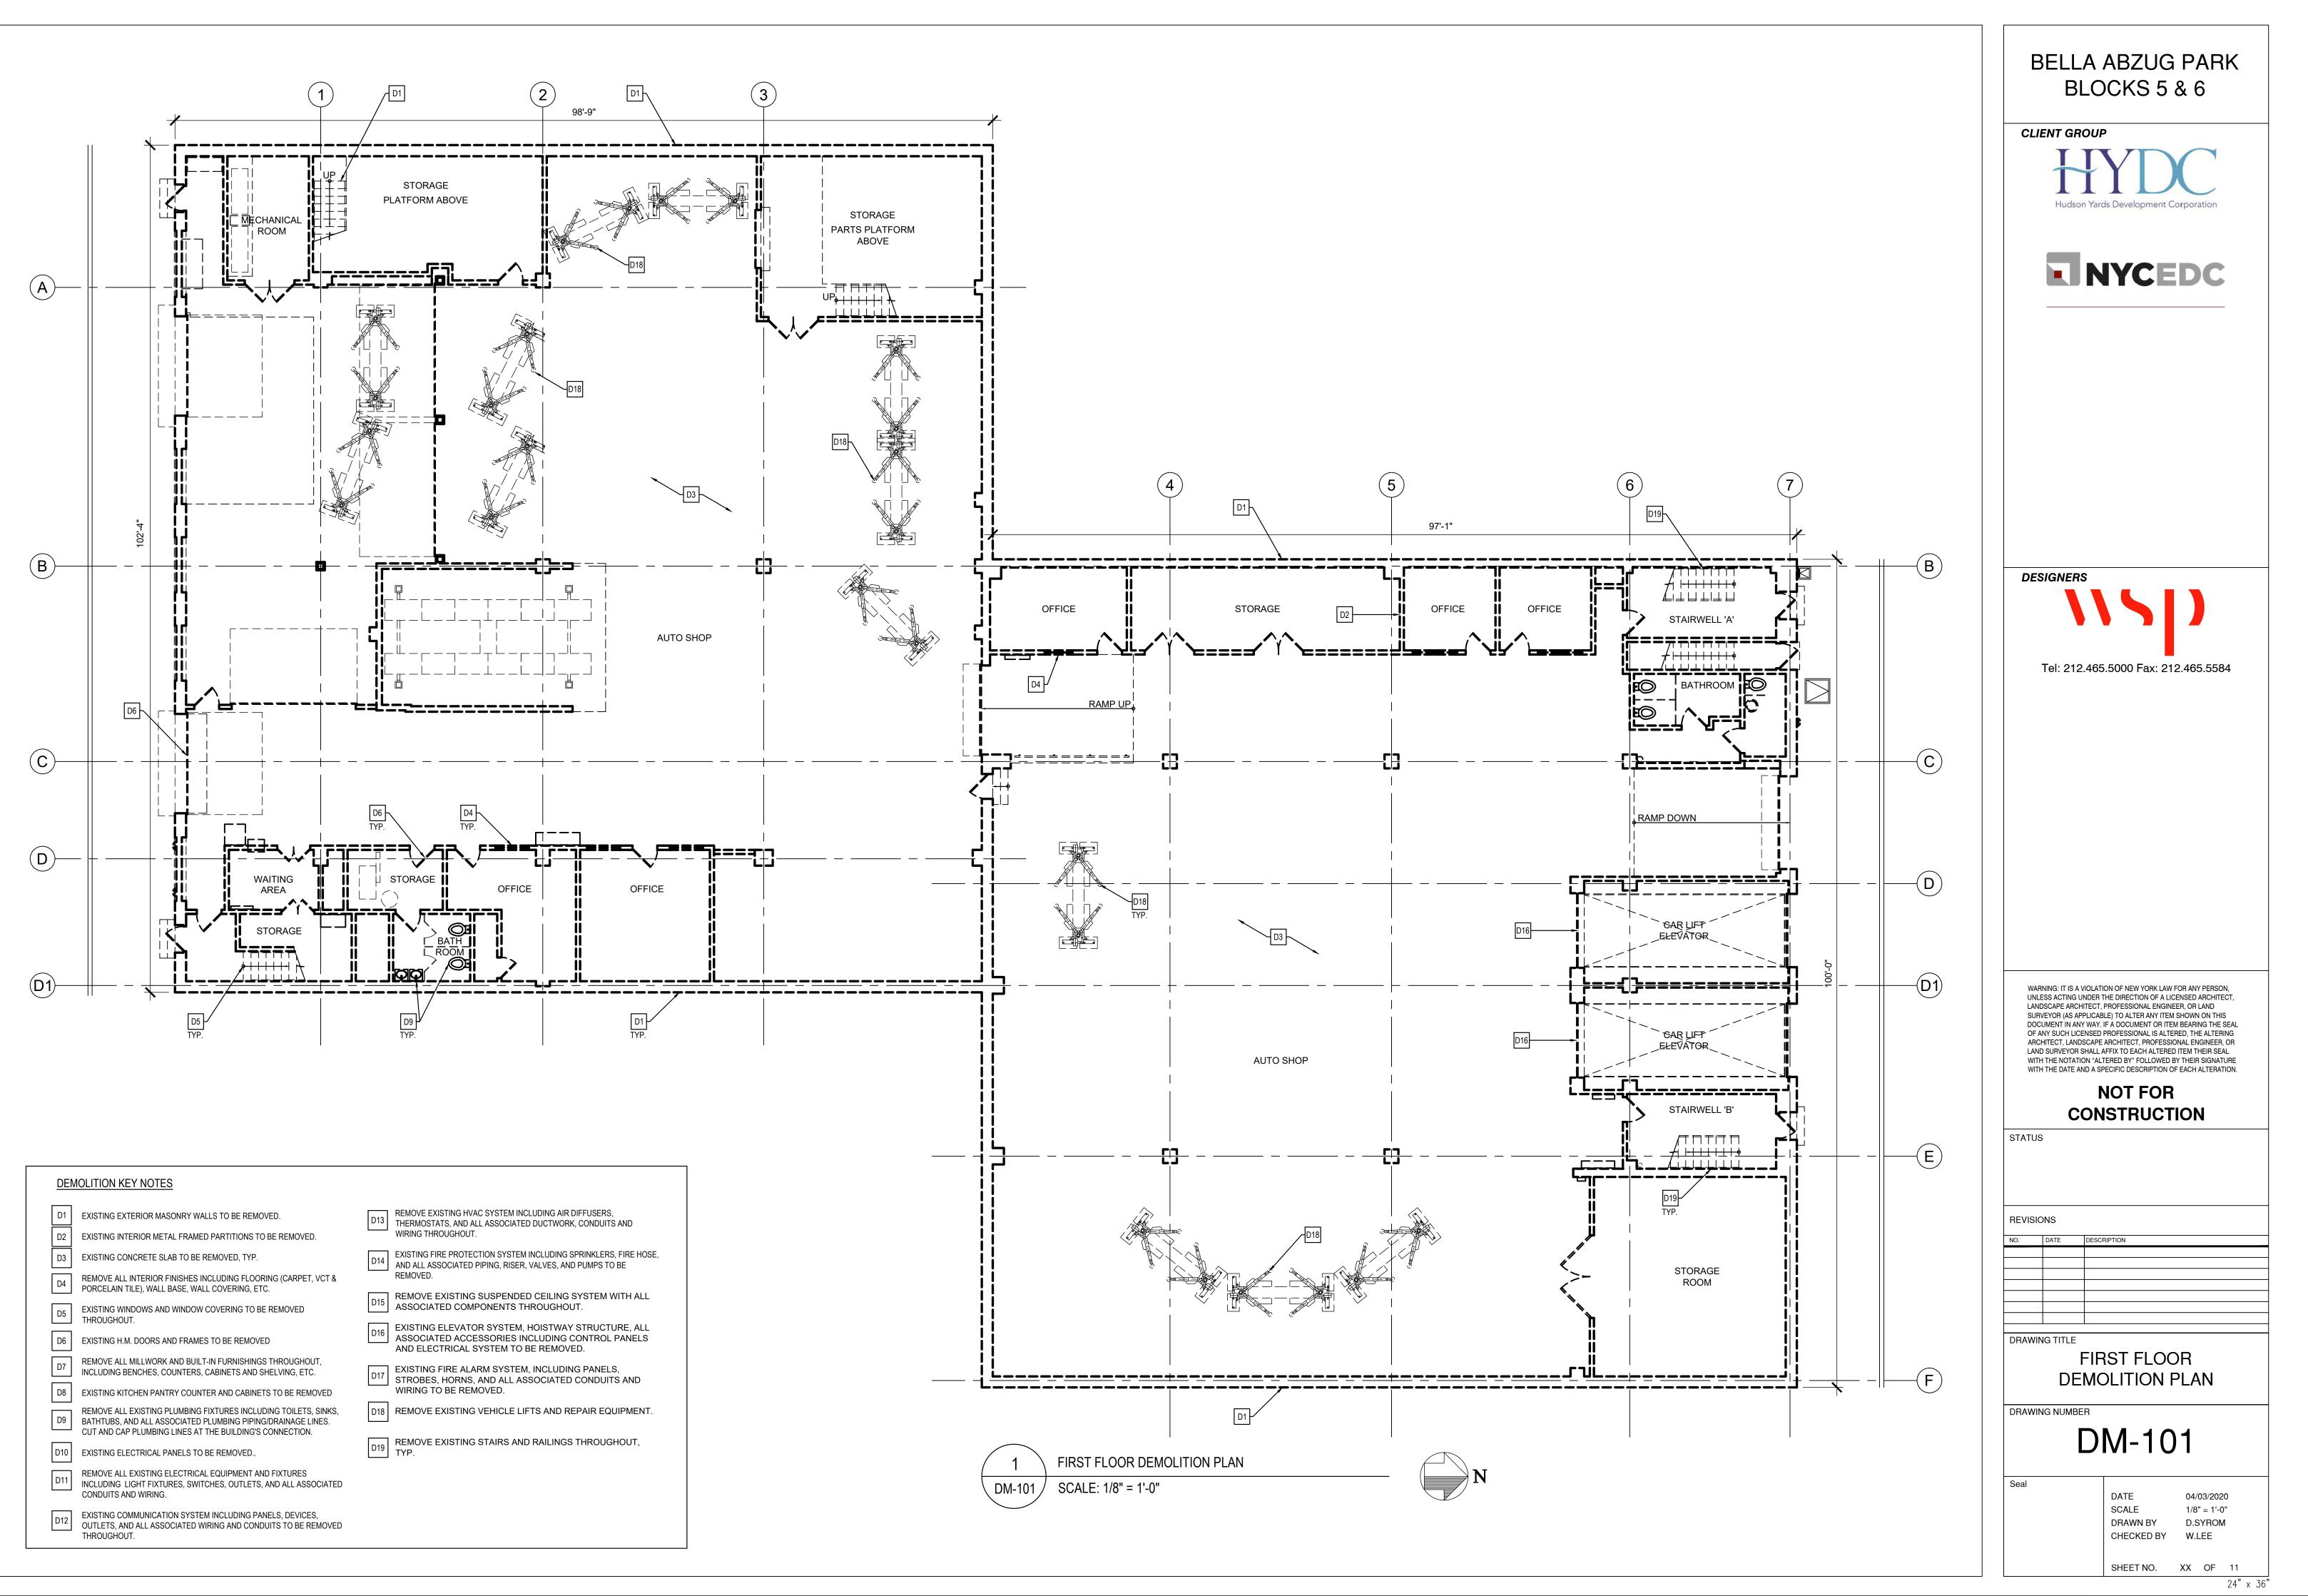


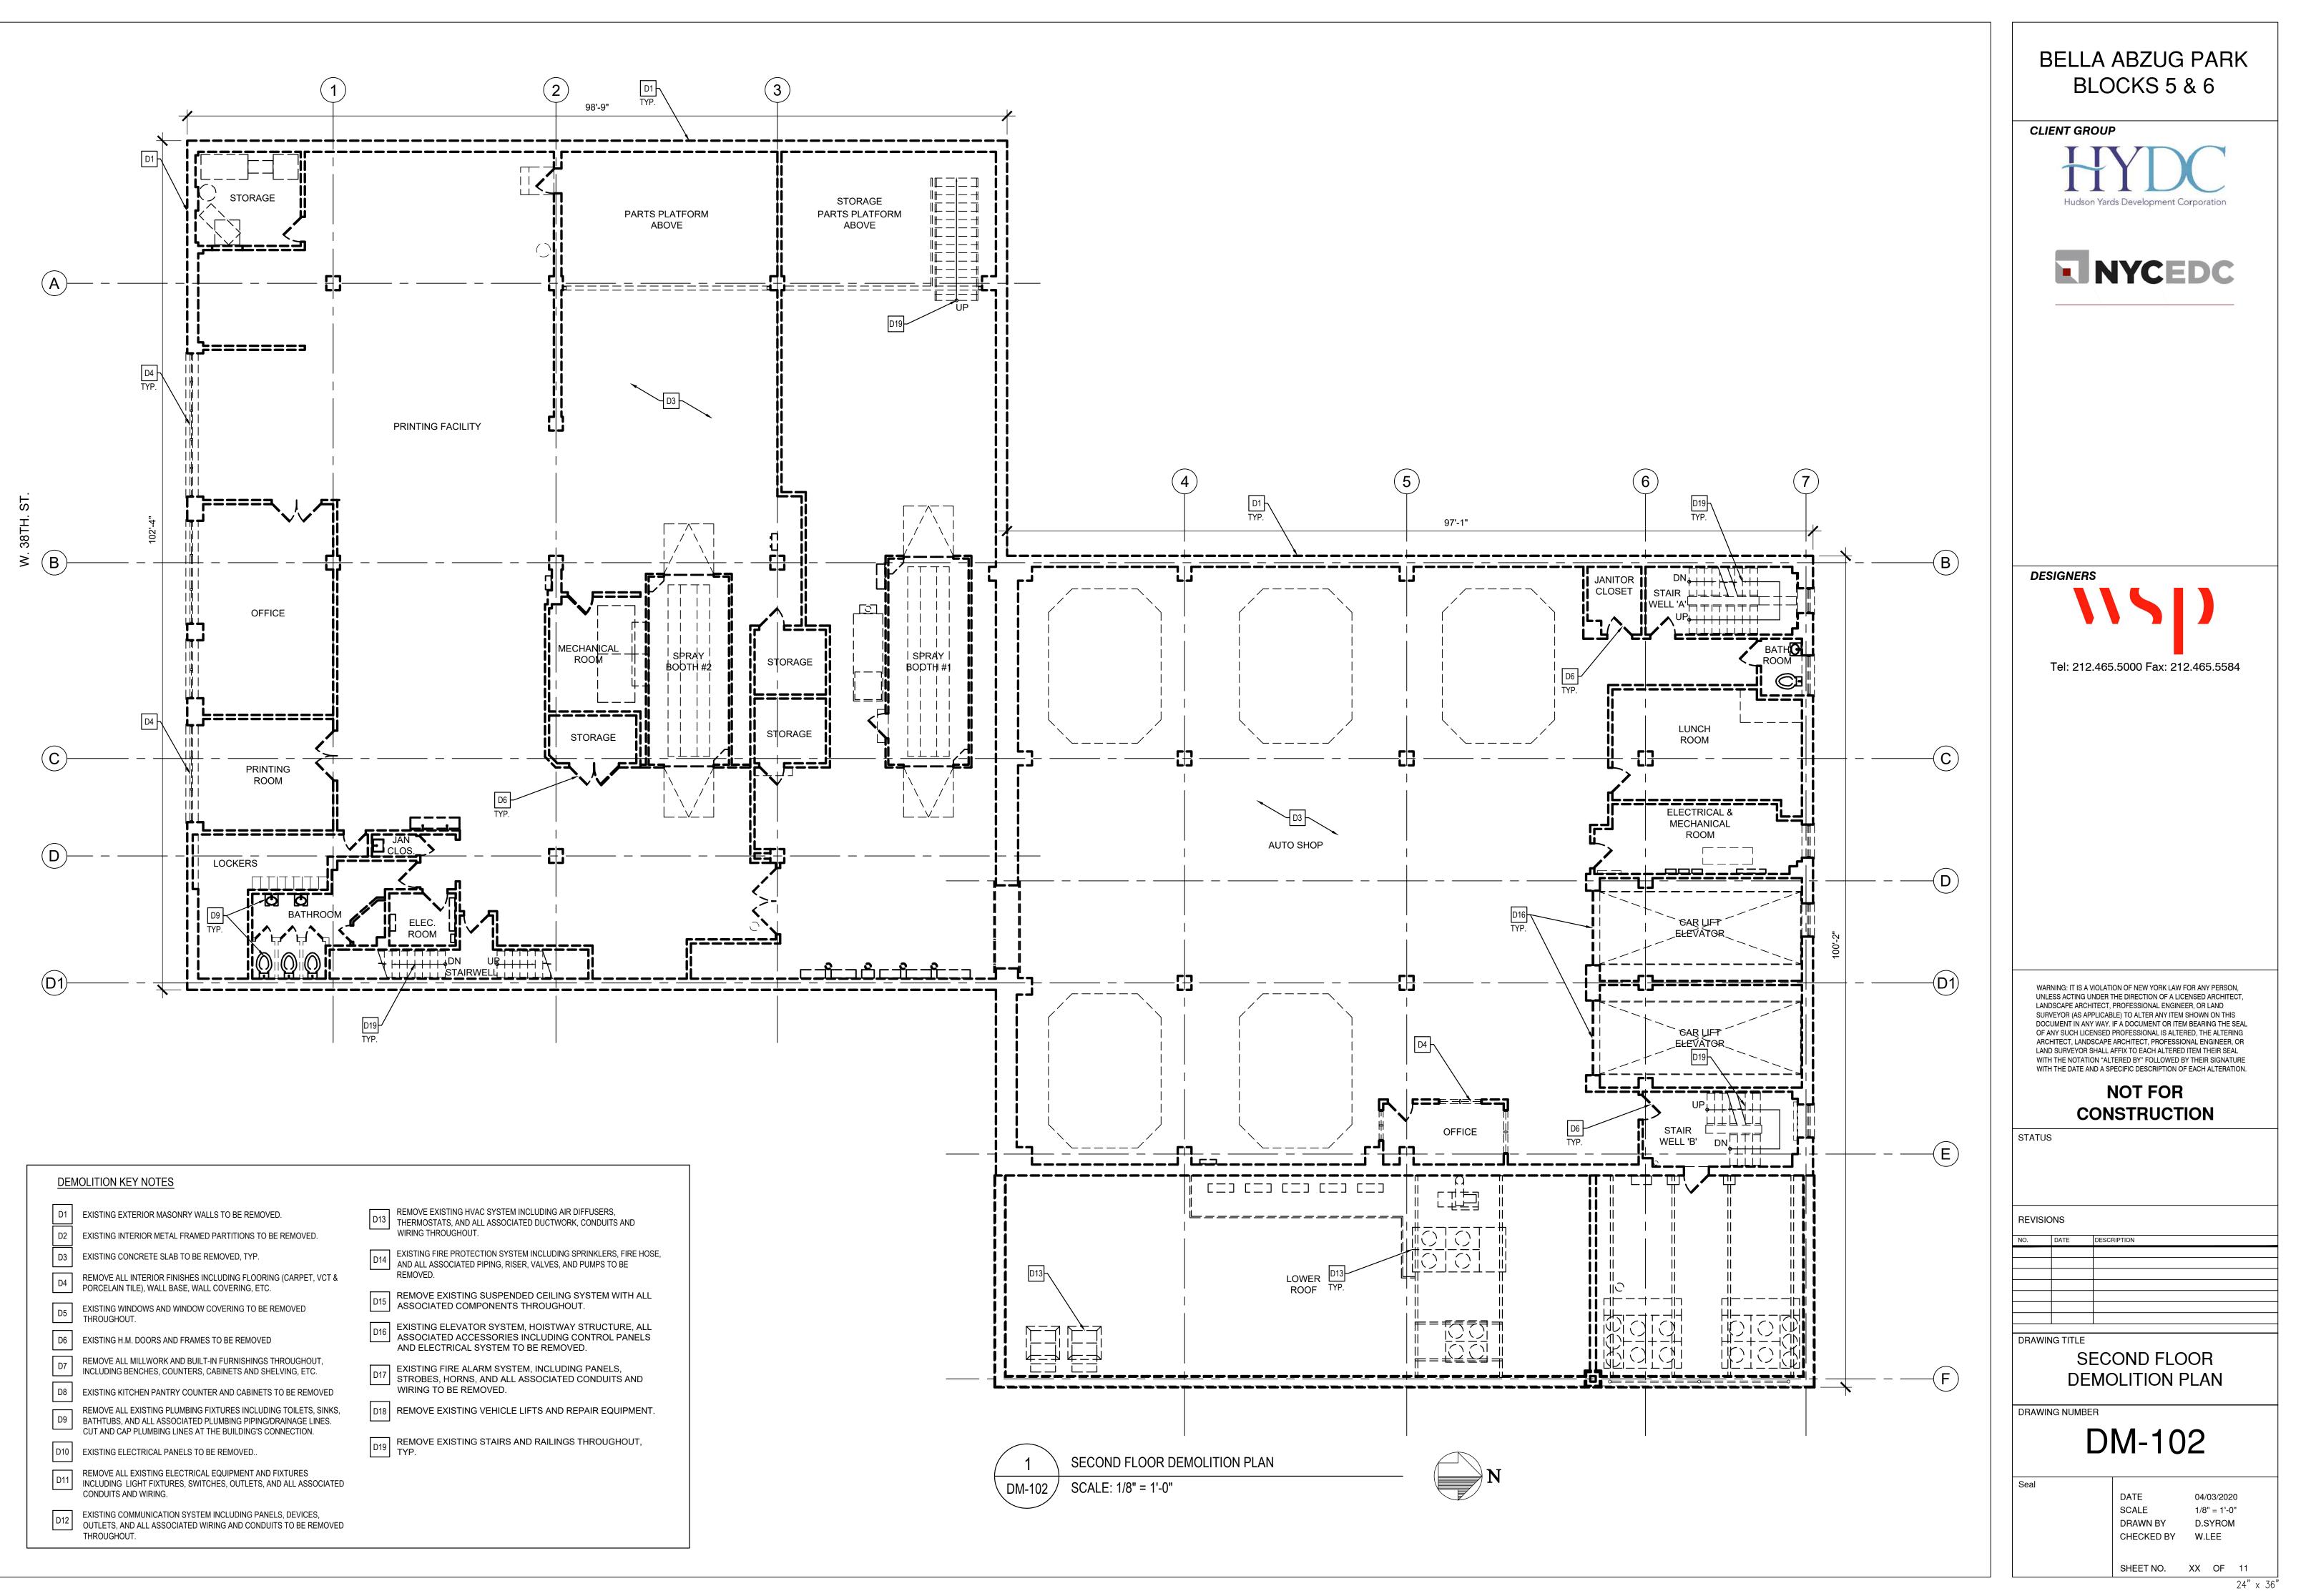



	D3	EXISTING CONCRETE SLAB TO BE REMOVED, TYP.	Γ
	D4	REMOVE ALL INTERIOR FINISHES INCLUDING FLOORING (CARPET, VCT & PORCELAIN TILE), WALL BASE, WALL COVERING, ETC.	Г
	D5	EXISTING WINDOWS AND WINDOW COVERING TO BE REMOVED THROUGHOUT.	
	D6	EXISTING H.M. DOORS AND FRAMES TO BE REMOVED	[
	D7	REMOVE ALL MILLWORK AND BUILT-IN FURNISHINGS THROUGHOUT, INCLUDING BENCHES, COUNTERS, CABINETS AND SHELVING, ETC.	Γ
	D8	EXISTING KITCHEN PANTRY COUNTER AND CABINETS TO BE REMOVED	
	D9	REMOVE ALL EXISTING PLUMBING FIXTURES INCLUDING TOILETS, SINKS, BATHTUBS, AND ALL ASSOCIATED PLUMBING PIPING/DRAINAGE LINES. CUT AND CAP PLUMBING LINES AT THE BUILDING'S CONNECTION.	[
	D10	EXISTING ELECTRICAL PANELS TO BE REMOVED	[
	D11	REMOVE ALL EXISTING ELECTRICAL EQUIPMENT AND FIXTURES INCLUDING LIGHT FIXTURES, SWITCHES, OUTLETS, AND ALL ASSOCIATED	

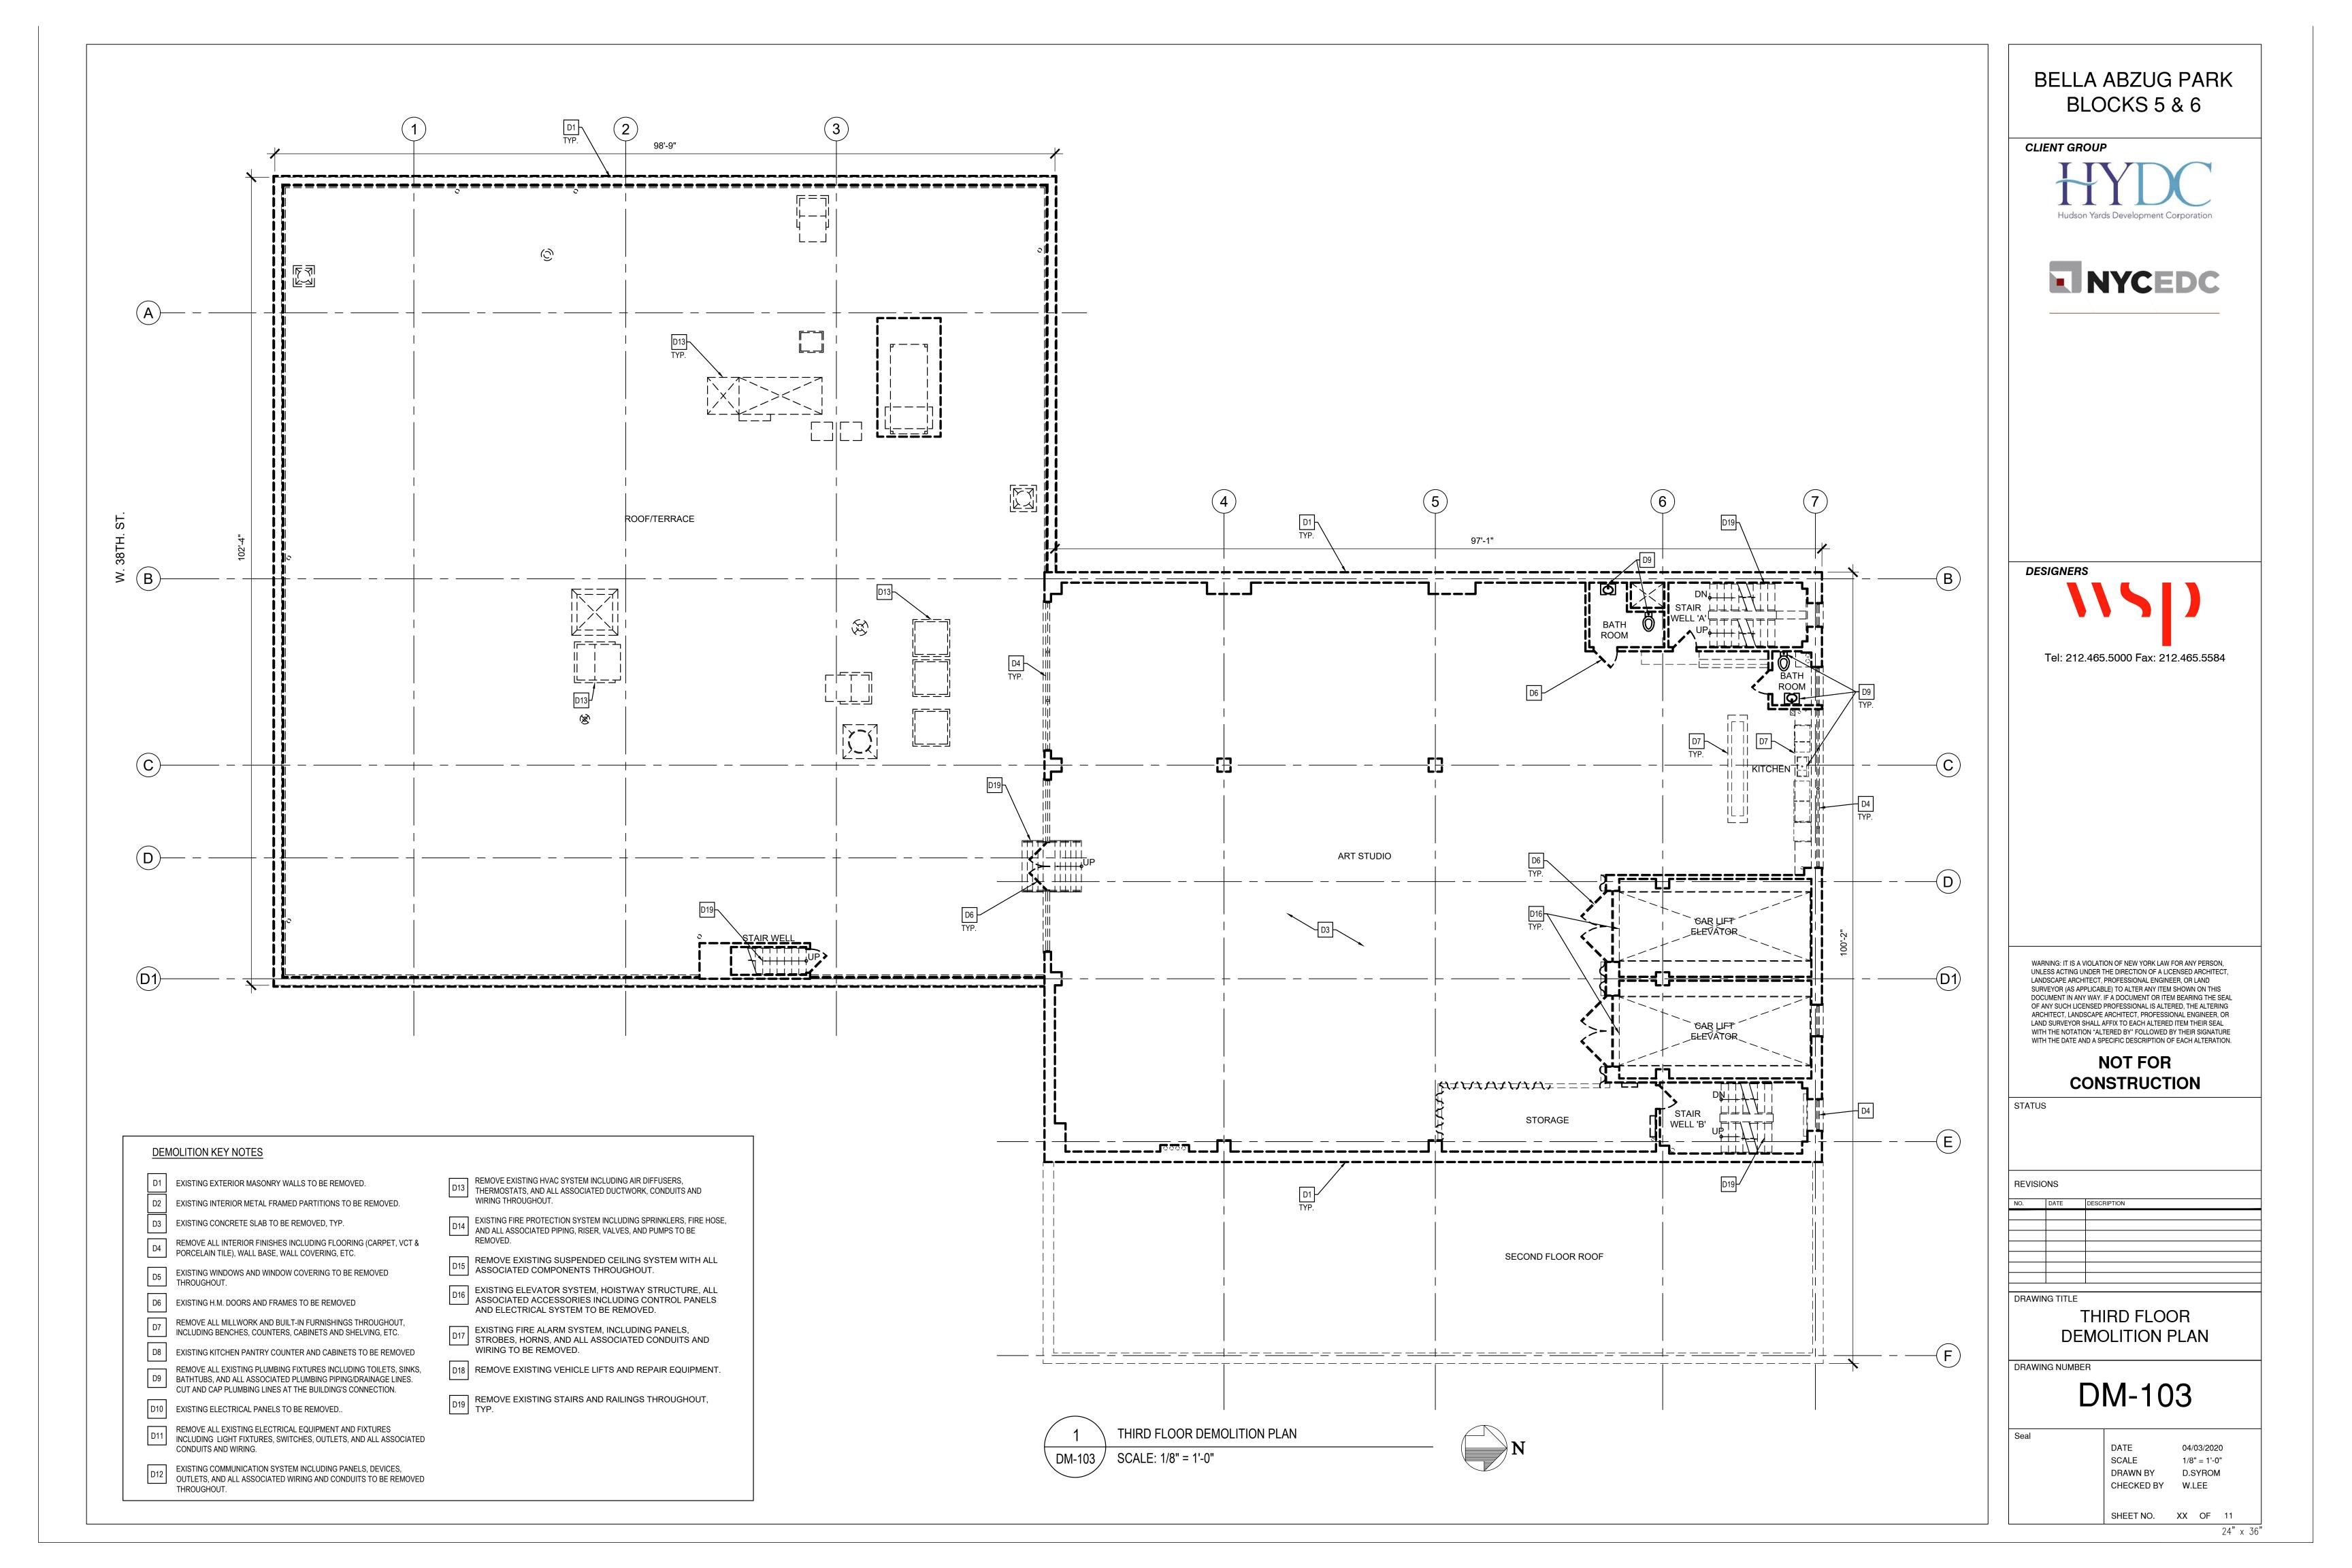

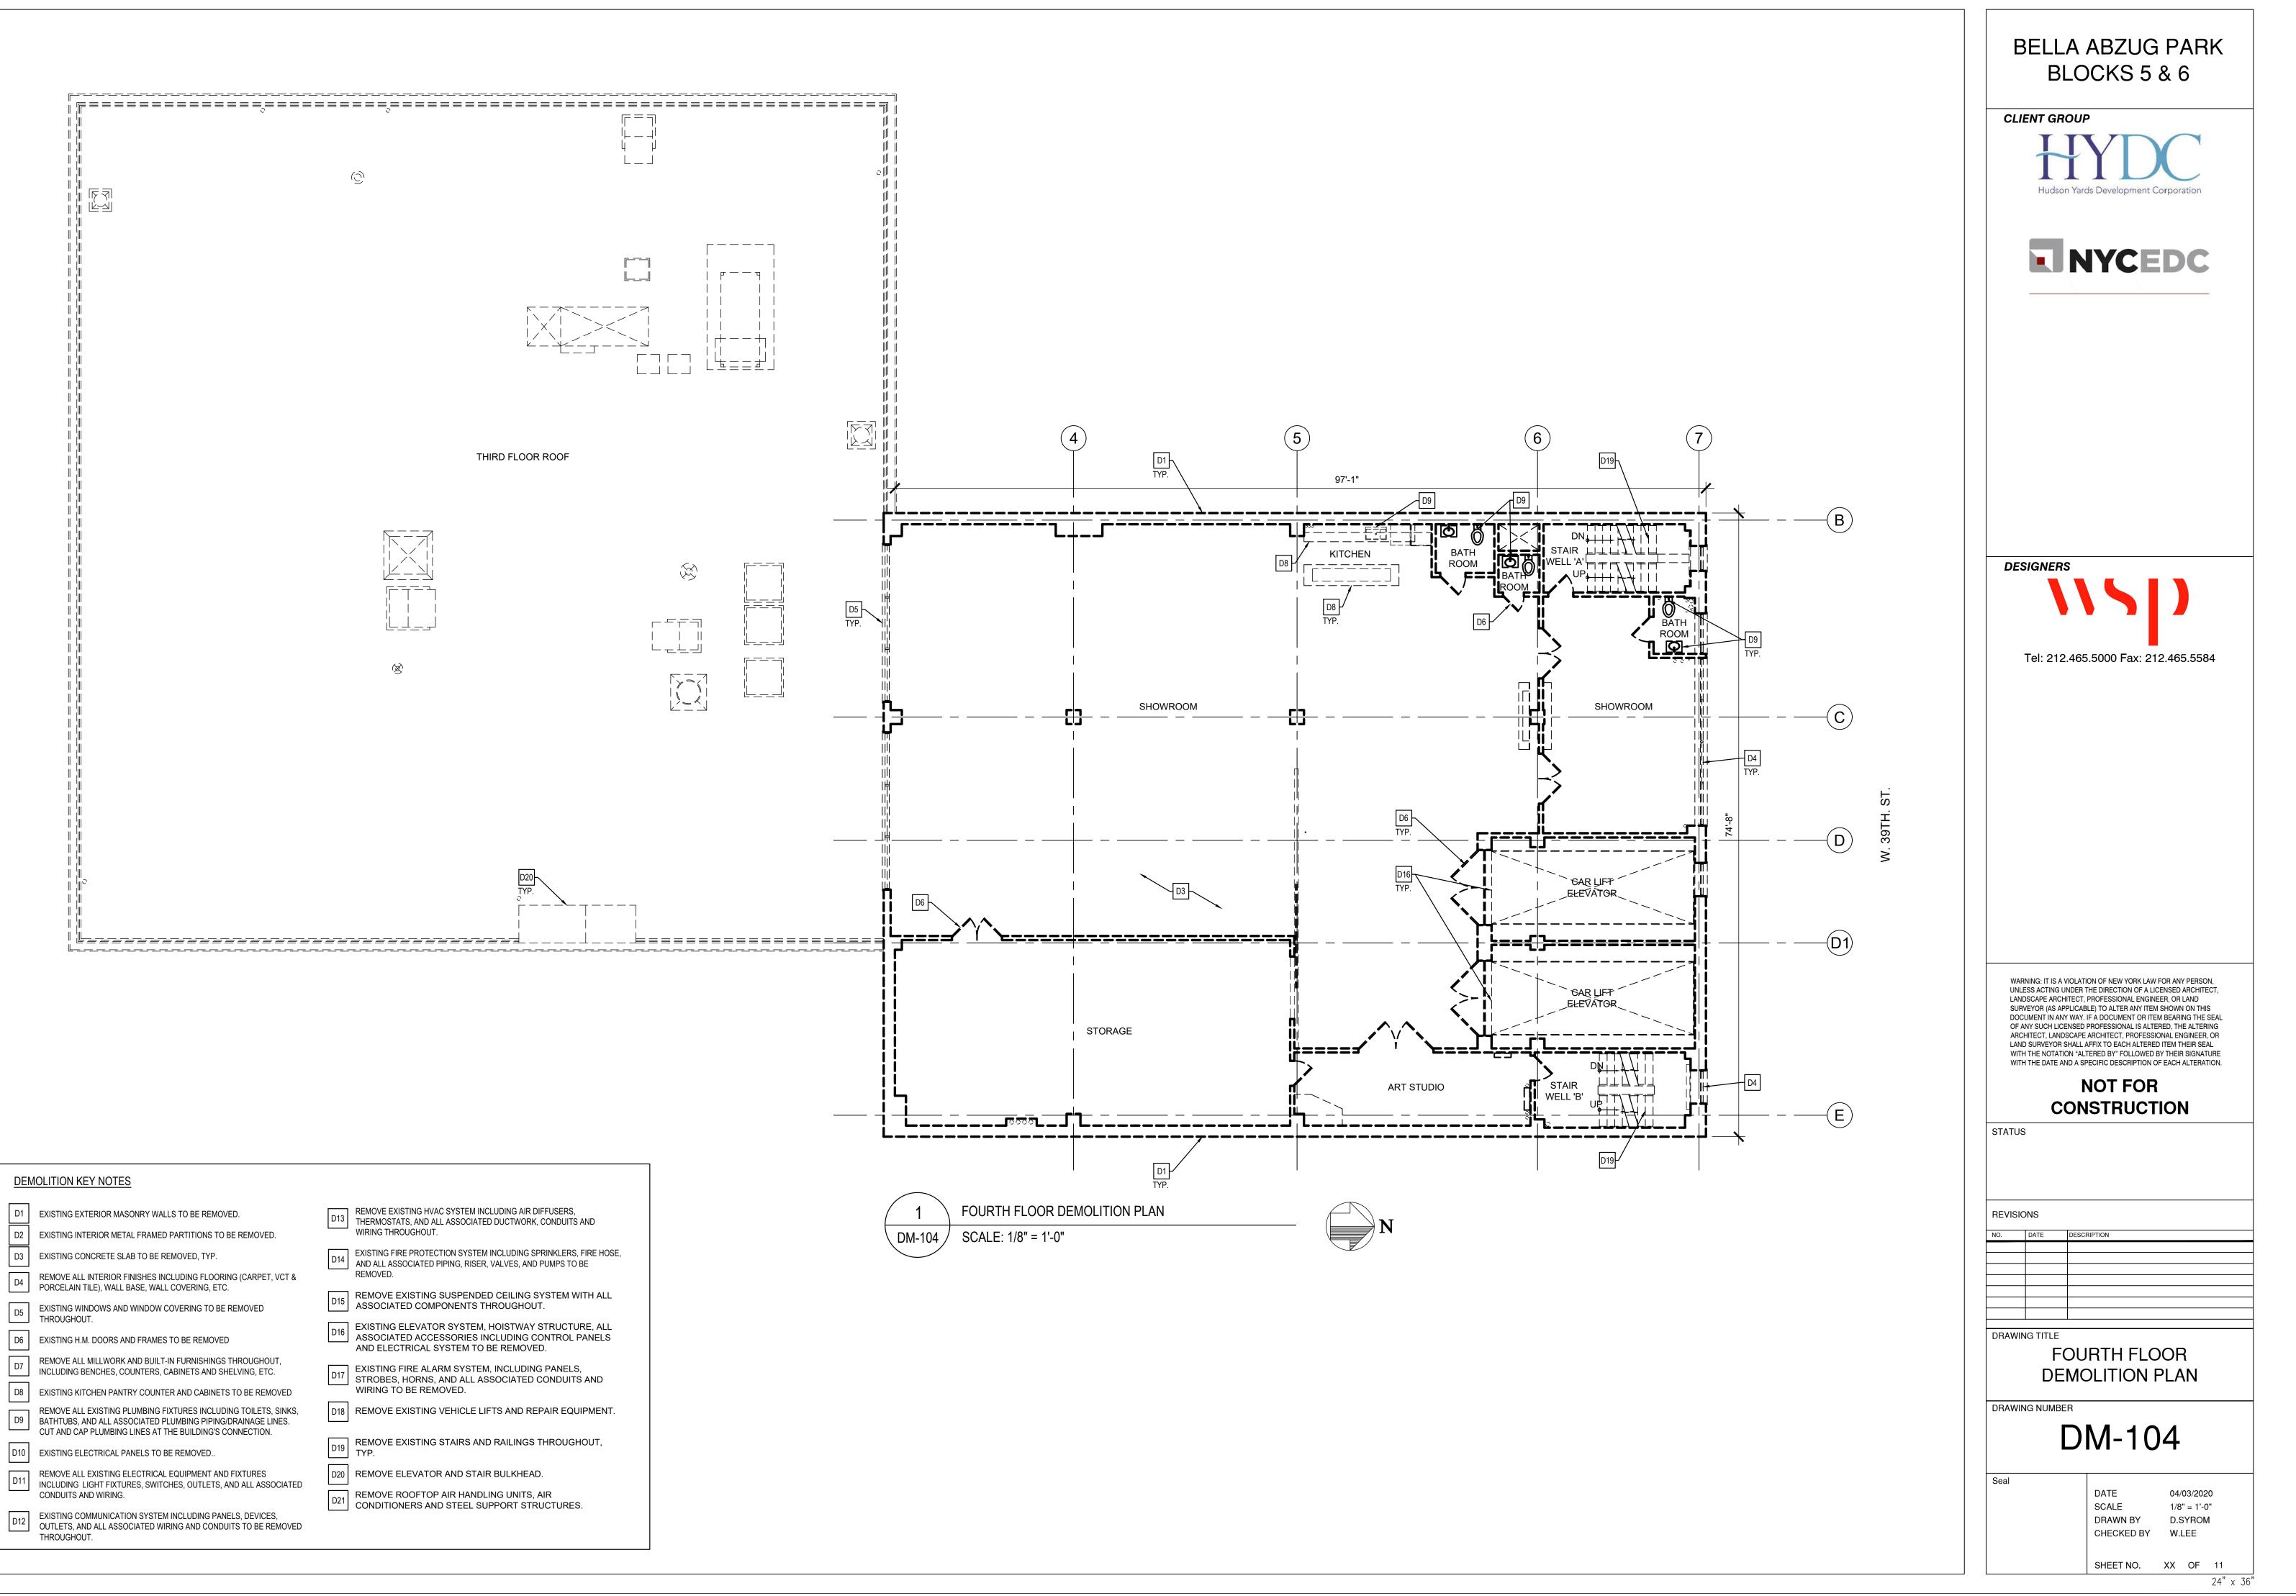


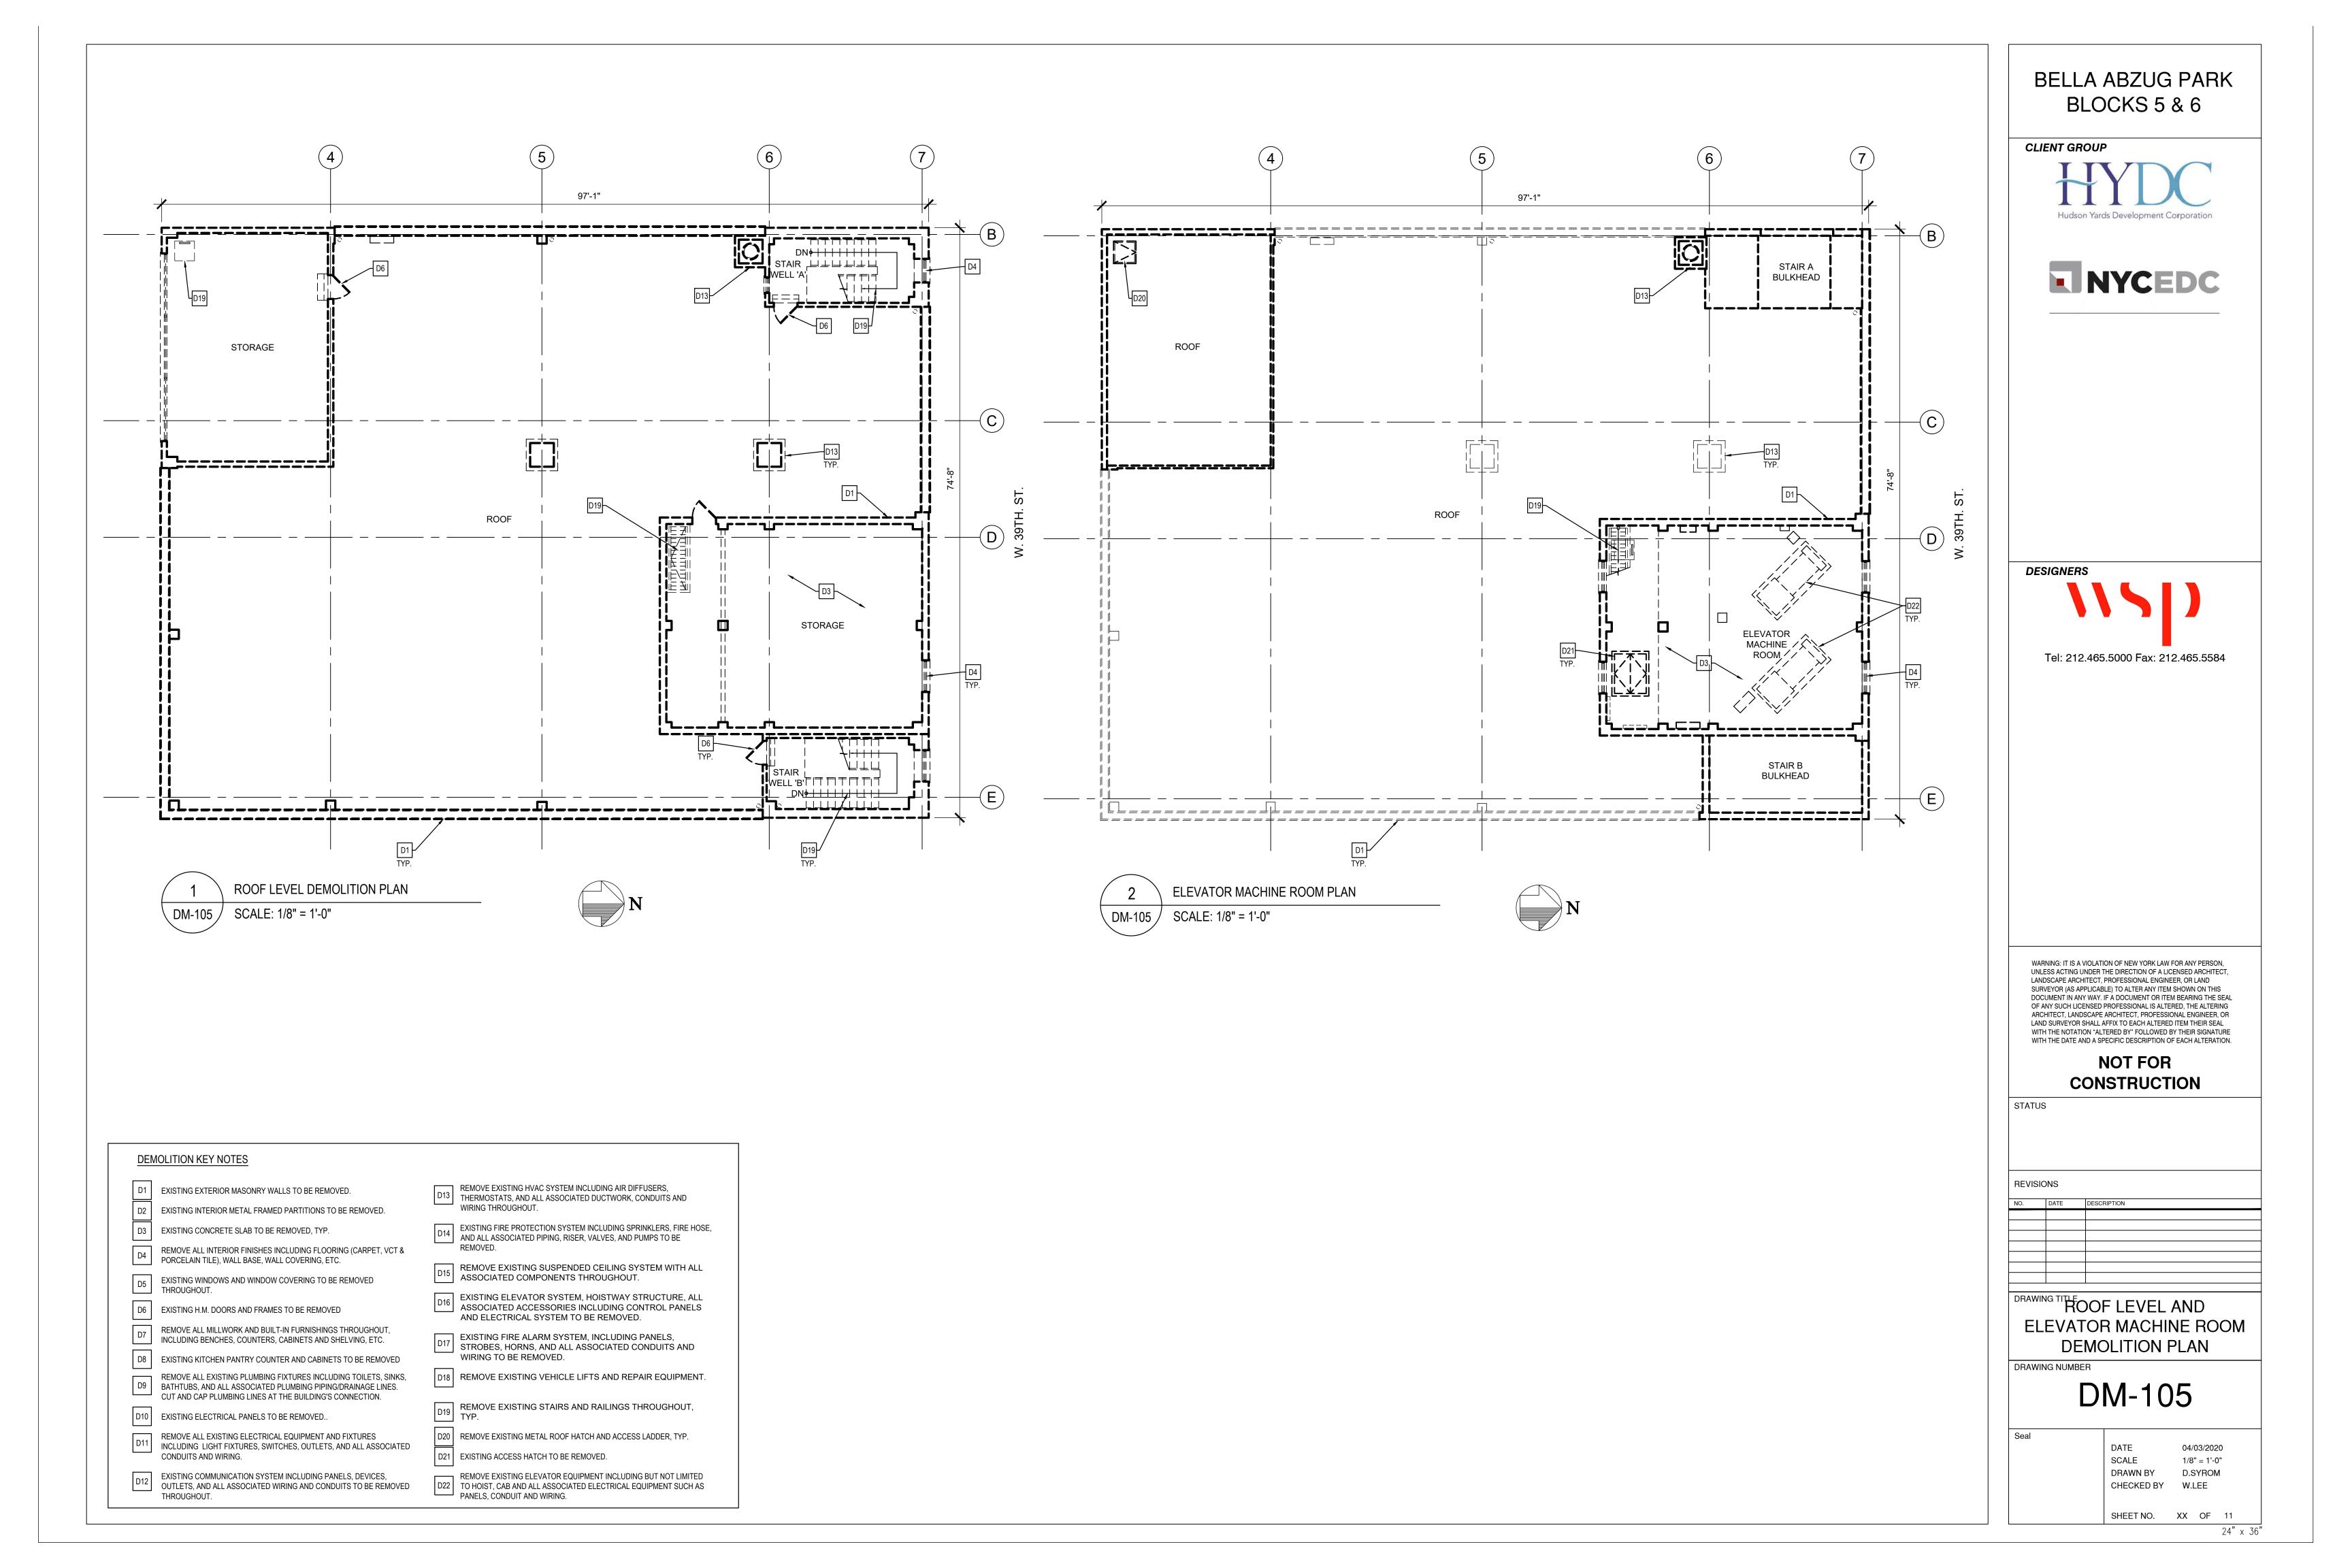


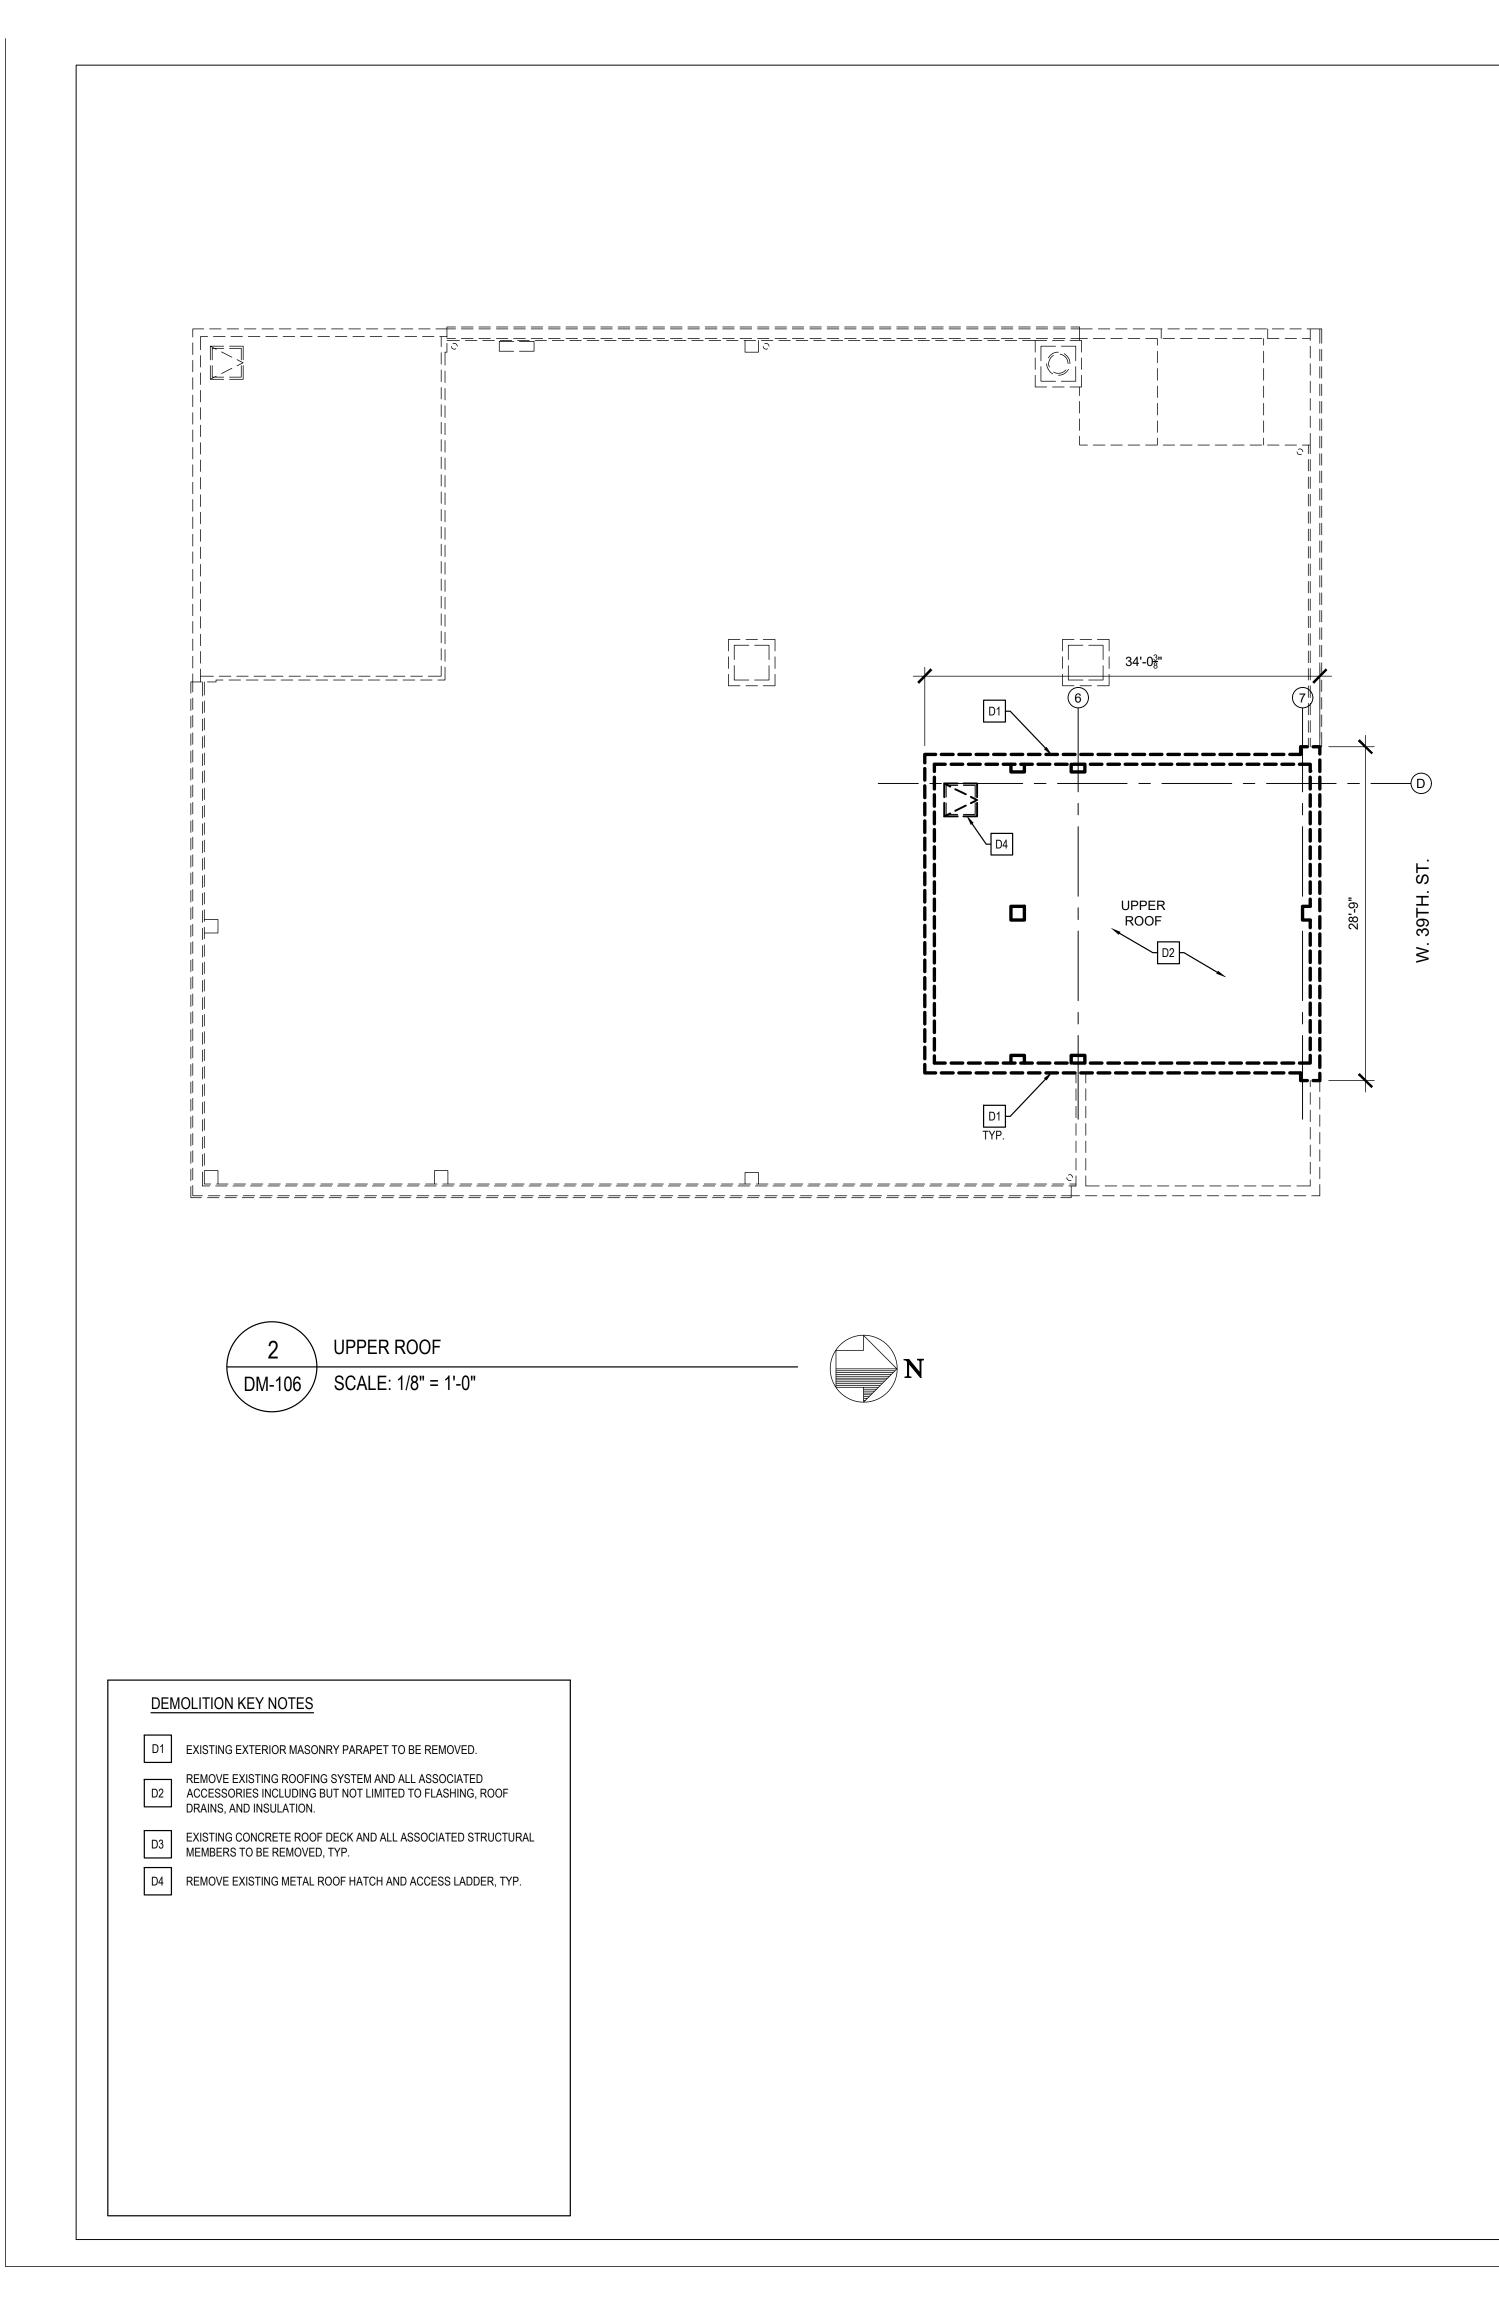


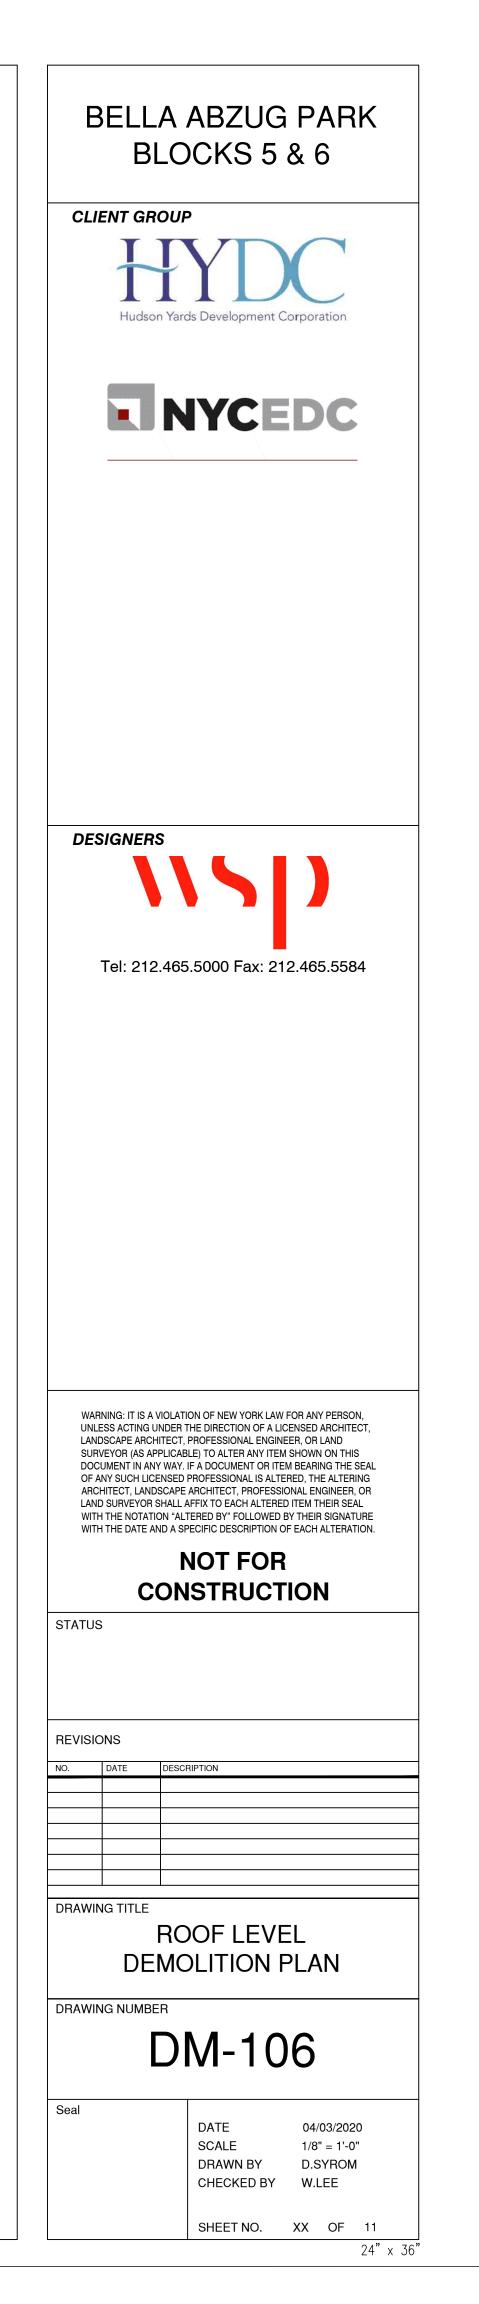

EL. ±88'-3" BULKHEAD ROOF EL. ±82'-10"							
TOP OF PARAPET EL. ±62'-2" ROOF EL. ±58'-2"							
4THFLOOR EL. ±45'-9"			D4				
TOP OF PARAPET EL. ±35'-10"			TYP.				₋Ĺ┦ ┱╸┫╼╴╸╸╴
ROOF EL. ±31'-10"				┓ ┽ ╎ ┽ ╎ ╴ ╎ ╴ ╎ ・ ╎ ・ ╎ ・ ╎ ・ ╎ ・ ╎ ・ ╎ ・ ╎ ・		┯┰┯╼ ┼┲┼┼╉ ┽╋┼┼╉ ┙┠╷╷┥╉ ═┨╧╧	┍╌┯╌┎╌┯╌┲ ┱┼┼╴┲╶┼╌╴┲ ╋┼┼╴┲╲┥╌┲ ╋╌┼╶╄╶╌╴┥ ┫┓┙┙
2ND FLOOR EL. ±16'-0"							
STREETLEVEL							
	1 DM-201		ELEVATION 1/8" = 1'-0"				
DEMOLITION KEY NOTES	MOVED.		E EXISTING HVAC SYS				
D2 EXISTING INTERIOR METAL FRAMED PARTITIONS D3 EXISTING CONCRETE SLAB TO BE REMOVED, TY	S TO BE REMOVED.		OSTATS, AND ALL AS THROUGHOUT. IG FIRE PROTECTION	SYSTEM INCLUDIN	IG SPRINKLERS,	FIRE HOSE,	
D4 REMOVE ALL INTERIOR FINISHES INCLUDING FLO PORCELAIN TILE), WALL BASE, WALL COVERING,	OORING (CARPET, VCT &	D14 AND AL REMOV	L ASSOCIATED PIPINO	G, RISER, VALVES,	AND PUMPS TO	BE	
D5 EXISTING WINDOWS AND WINDOW COVERING TO THROUGHOUT.	D BE REMOVED		CIATED COMPONE	ENTS THROUGH 'STEM, HOISTW	IOUT. /AY STRUCTU	RE, ALL	
D6 EXISTING H.M. DOORS AND FRAMES TO BE REMO REMOVE ALL MILLWORK AND BUILT-IN FURNISHI	NGS THROUGHOUT,	ASSOC AND E	CIATED ACCESSO	RIES INCLUDIN EM TO BE REMO	G CONTROL F OVED.	PANELS	
D7 INCLUDING BENCHES, COUNTERS, CABINETS AN D8 EXISTING KITCHEN PANTRY COUNTER AND CABI	ID SHELVING, ETC.	D17 STROE	NG FIRE ALARM S BES, HORNS, AND G TO BE REMOVE	ALL ASSOCIAT			
D9 REMOVE ALL EXISTING PLUMBING FIXTURES INC BATHTUBS, AND ALL ASSOCIATED PLUMBING PIF CUT AND CAP PLUMBING LINES AT THE BUILDING		D18 REMO					
·				ICLE LIFTS ANL) REPAIR EQU		
D10 EXISTING ELECTRICAL PANELS TO BE REMOVED	G'S CONNECTION.	TYP.	VE EXISTING STA	RS AND RAILIN	GS THROUGH		
	G'S CONNECTION.) AND FIXTURES	D19 TYP. D20 REMO		RS AND RAILIN D STAIR BULKH HANDLING UNI	GS THROUGH IEAD. TS, AIR	IOUT,	

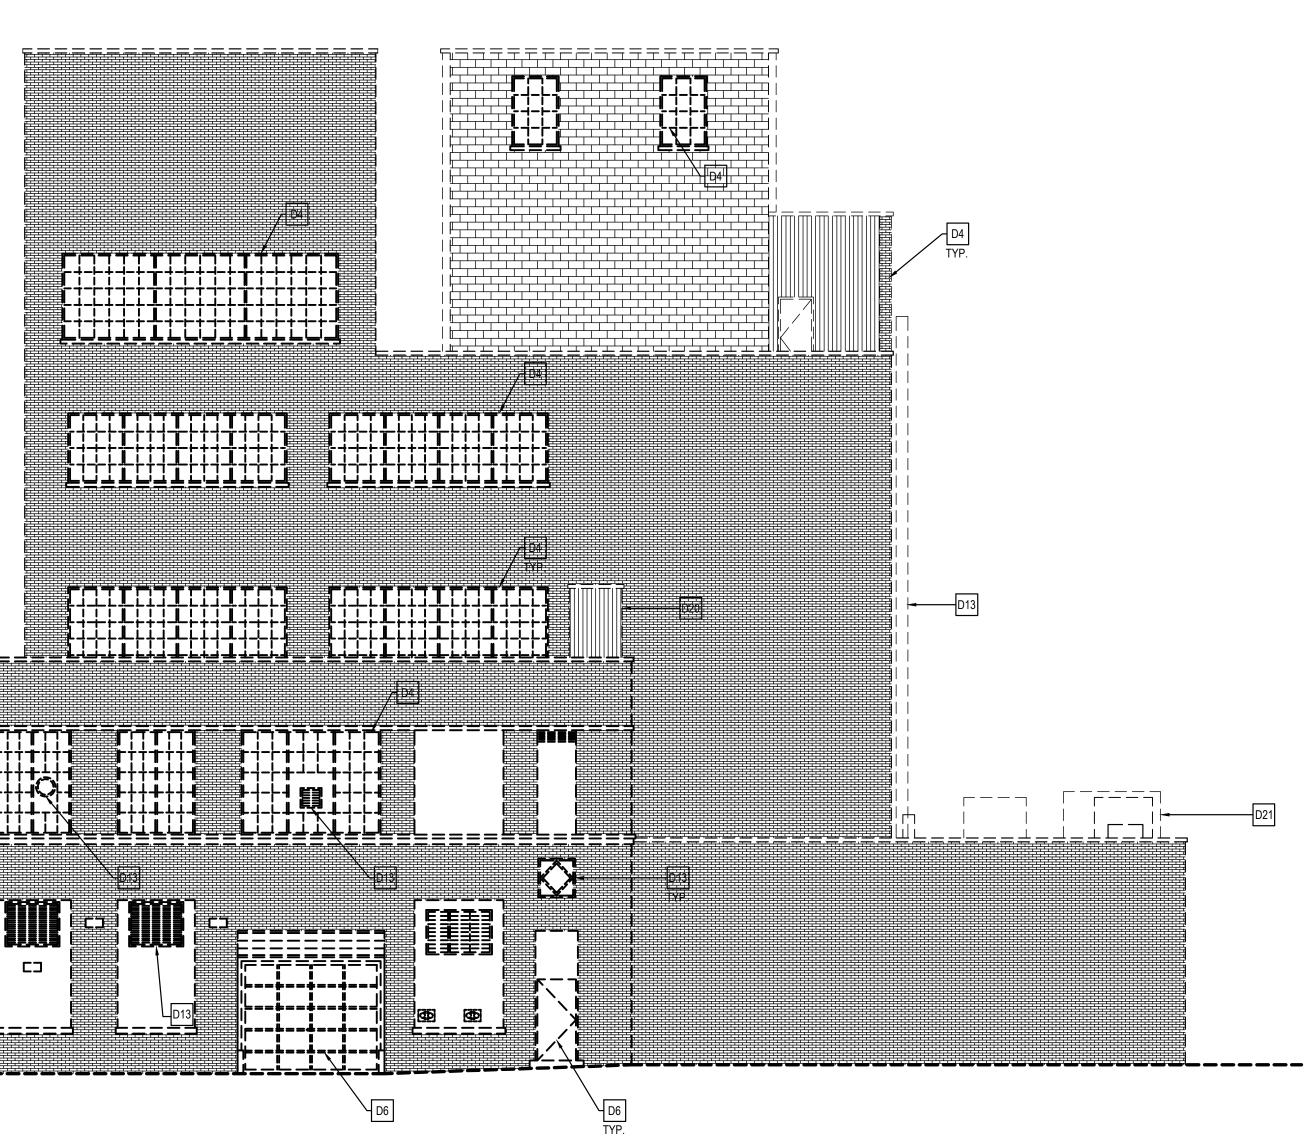

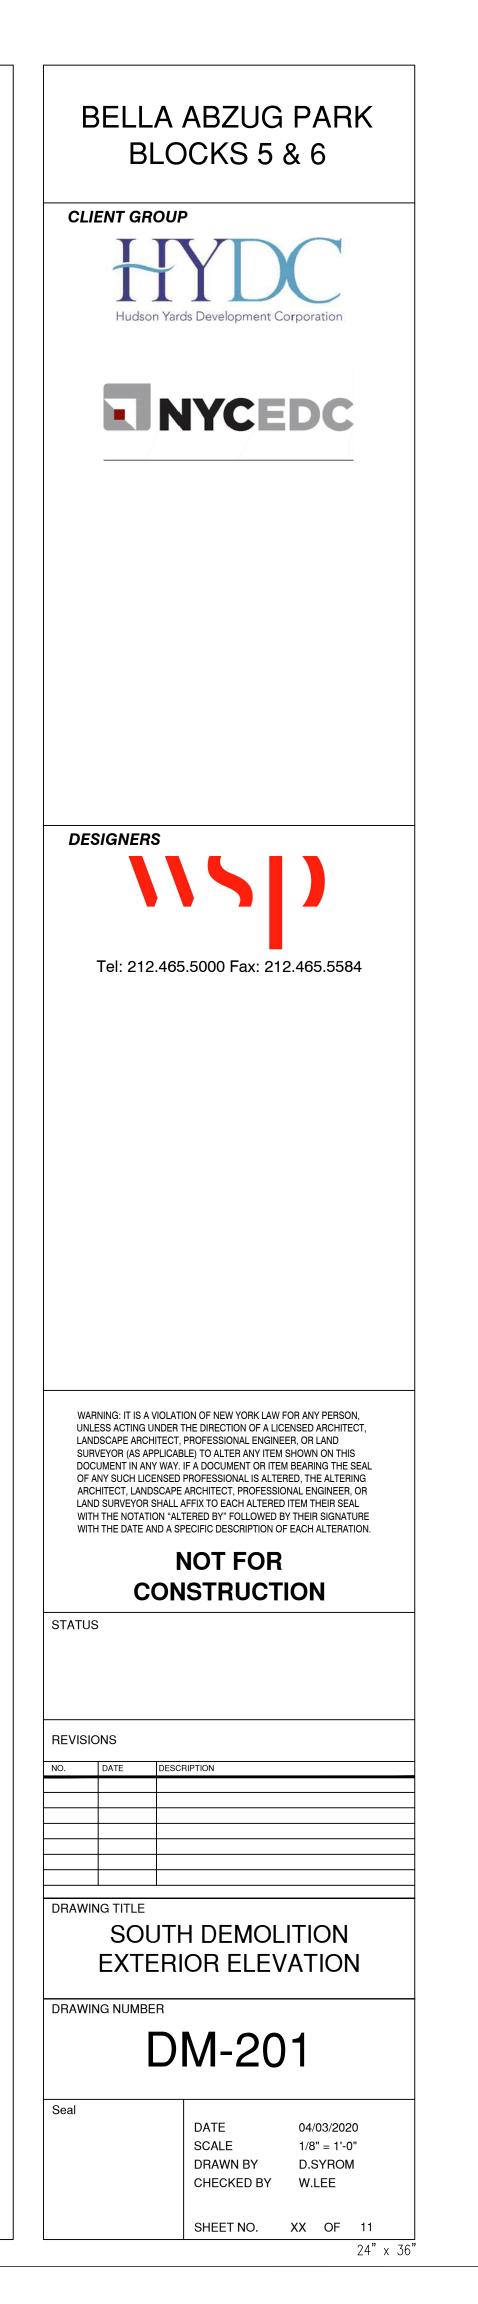

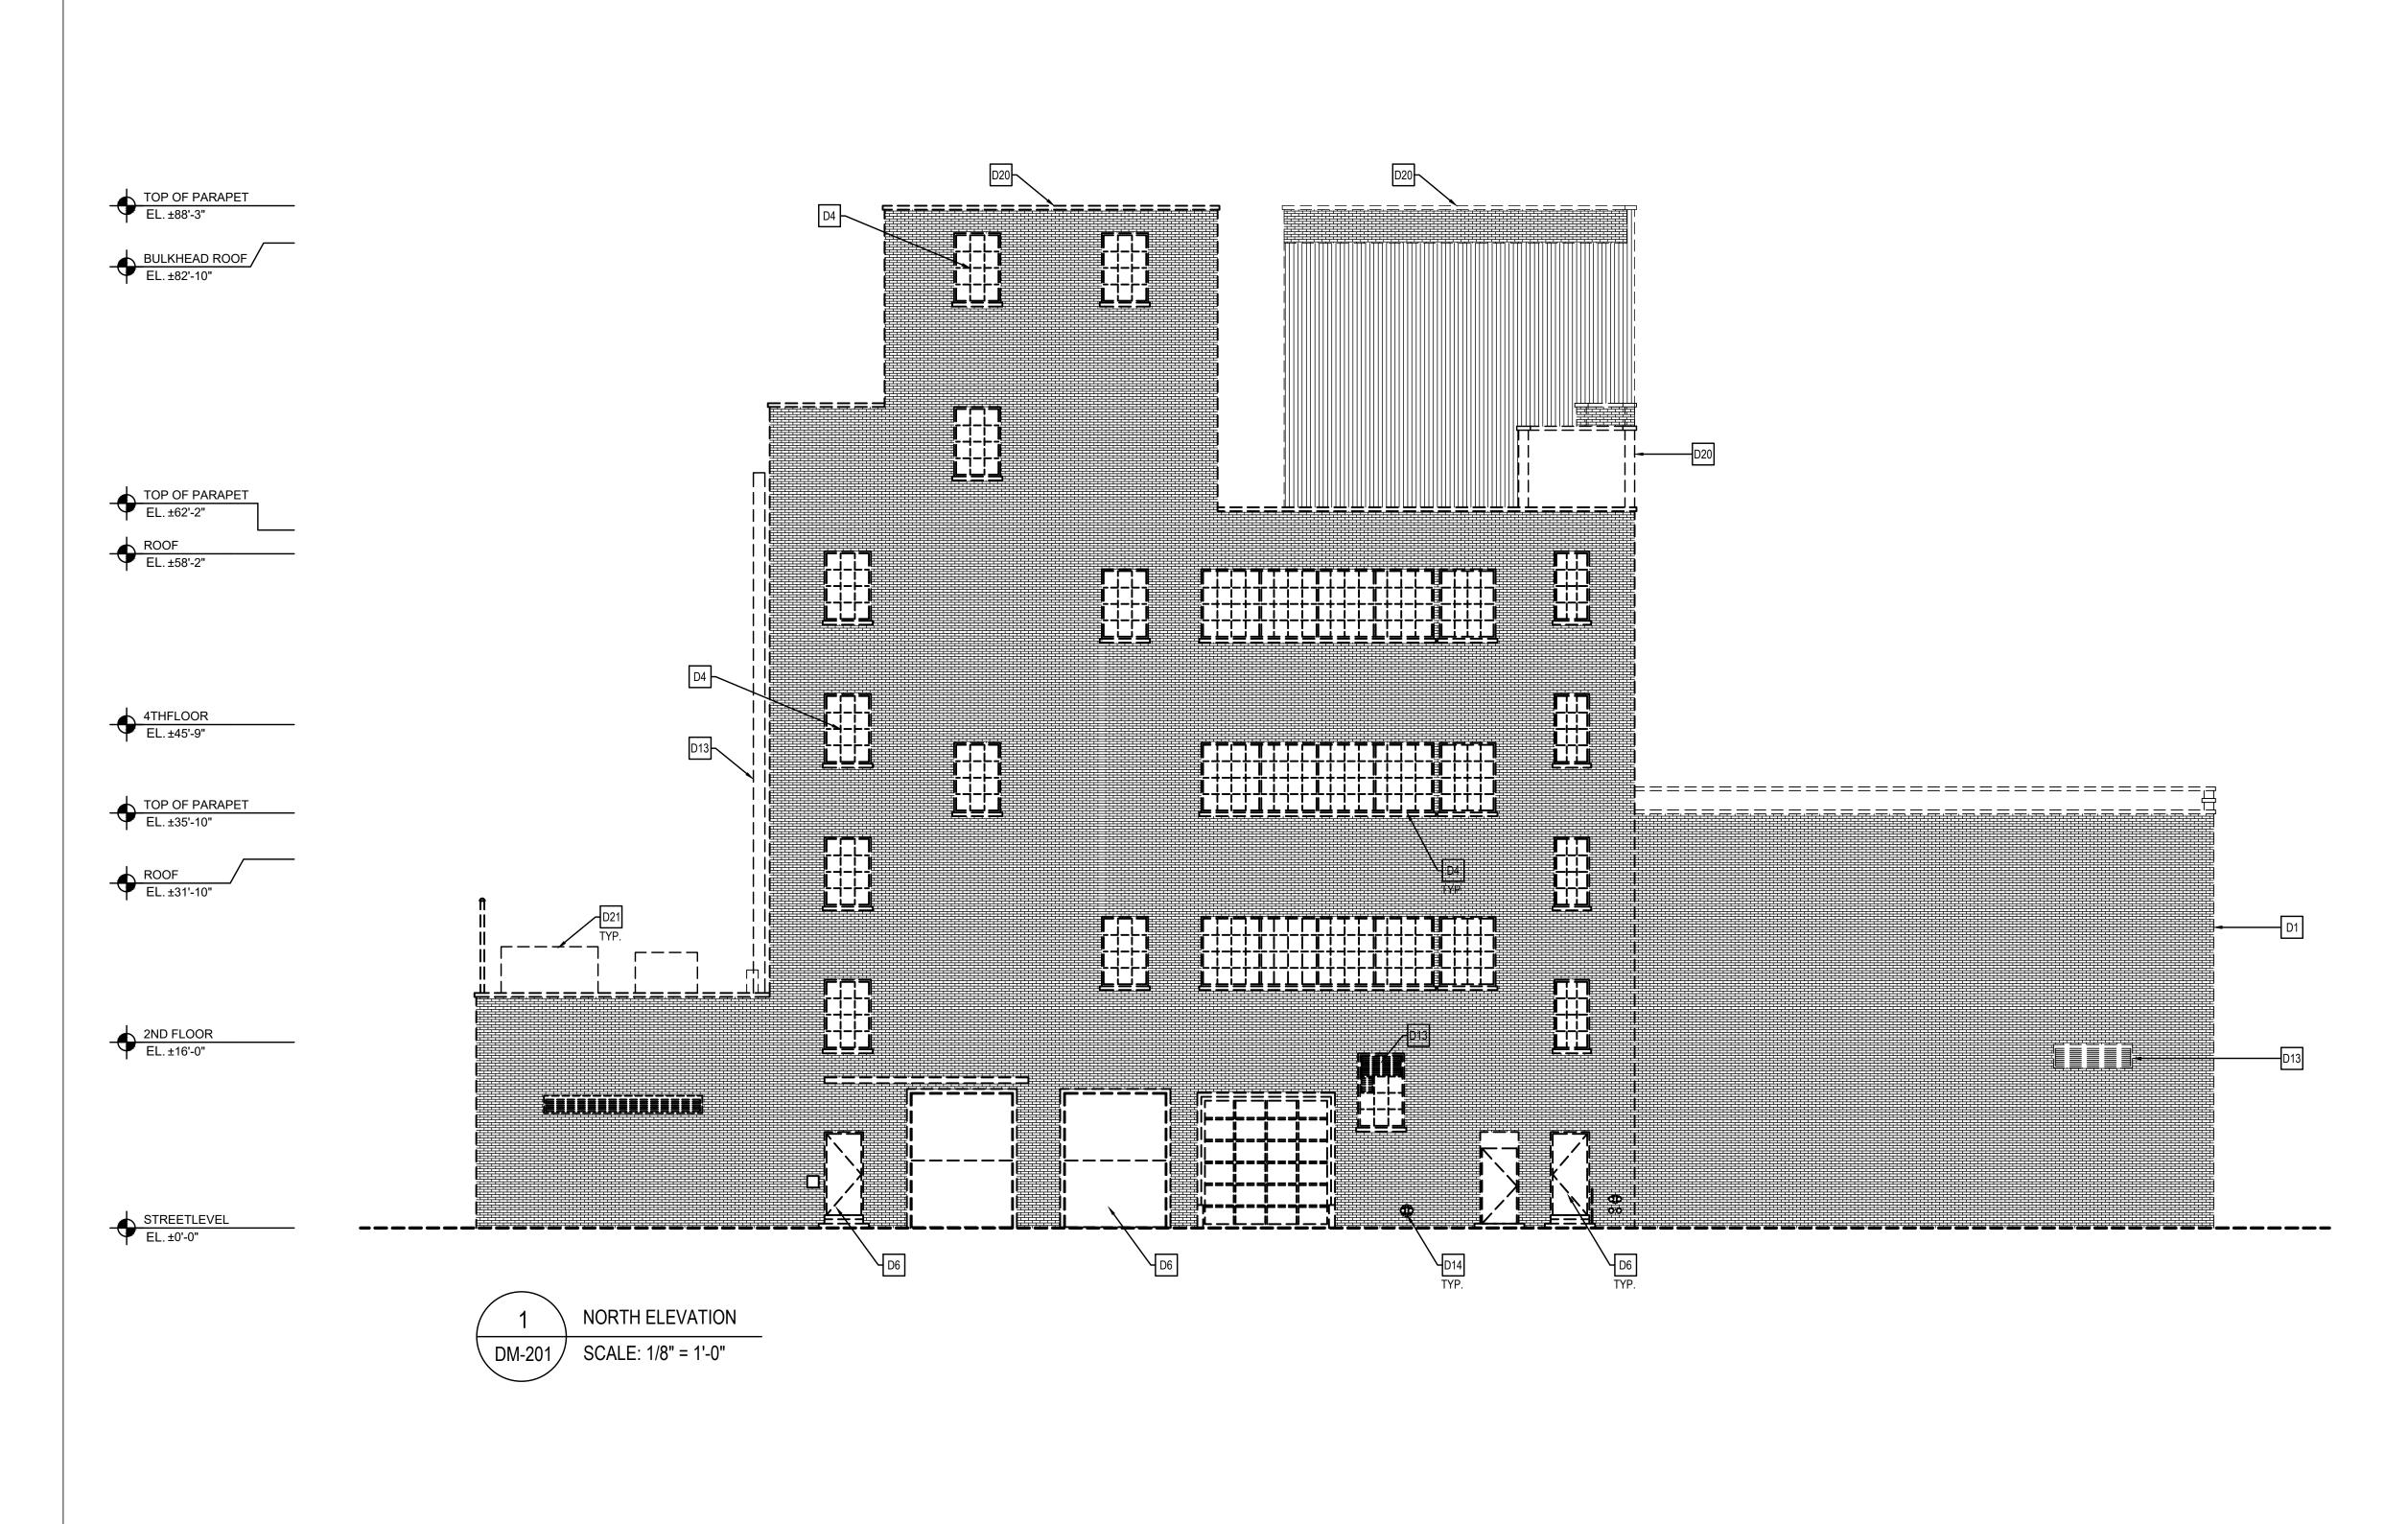

DEMOLITION KEY NOTES

D1	EXISTING EXTERIOR MASONRY WALLS TO BE REMOVED.
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 D14
 EXISTING FIRE PROTECTION SYSTEM INCLUDING SPRINKLERS, FIRE HOSE, AND ALL ASSOCIATED PIPING, RISER, VALVES, AND PUMPS TO BE REMOVED.

 D15
 REMOVE EXISTING SUSPENDED CEILING SYSTEM WITH ALL ASSOCIATED COMPONENTS THROUGHOUT.

 D16
 EXISTING ELEVATOR SYSTEM, HOISTWAY STRUCTURE, ALL ASSOCIATED ACCESSORIES INCLUDING CONTROL PANELS, AND ELECTRICAL SYSTEM TO BE REMOVED.

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 REMOVE EXISTING VEHICLE LIFTS AND REPAIR EQUIPMENT.


 D19
 REMOVE EXISTING STAIRS AND RAILINGS THROUGHOUT, TYP.

 D20
 REMOVE ELEVATOR AND STAIR BULKHEAD.

 D21
 REMOVE ROOFTOP AIR HANDLING UNITS, AIR CONDITIONERS AND STEEL SUPPORT STRUCTURES.

BELLA ABZUG PARK BLOCKS 5 & 6
CLIENT GROUP
DESIGNERS
Tel: 212.465.5000 Fax: 212.465.5584
WARNING: IT IS A VIOLATION OF NEW YORK LAW FOR ANY PERSON,
UNLESS ACTING UNDER THE DIRECTION OF A LICENSED ARCHITECT, LANDSCAPE ARCHITECT, PROFESSIONAL ENGINEER, OR LAND SURVEYOR (AS APPLICABLE) TO ALTER ANY ITEM SHOWN ON THIS DOCUMENT IN ANY WAY. IF A DOCUMENT OR ITEM BEARING THE SEAL OF ANY SUCH LICENSED PROFESSIONAL IS ALTERED, THE ALTERING ARCHITECT, LANDSCAPE ARCHITECT, PROFESSIONAL ENGINEER, OR LAND SURVEYOR SHALL AFFIX TO EACH ALTERED ITEM THEIR SEAL WITH THE NOTATION "ALTERED BY" FOLLOWED BY THEIR SIGNATURE WITH THE DATE AND A SPECIFIC DESCRIPTION OF EACH ALTERATION. NOTT FOR
STATUS
REVISIONS
NO. DATE DESCRIPTION
DRAWING TITLE NORTH DEMOLITION EXTERIOR ELEVATION
DRAWING NUMBER DN-202
Seal DATE 04/03/2020 SCALE 1/8" = 1'-0" DRAWN BY D.SYROM CHECKED BY W.LEE
SHEET NO. XX OF 11

EL. ±88'-3"				
EL. ±82'-10"				
TOP OF PARAPET EL. ±62'-2"				
✓ EL. ±58'-2"				
1				
4THFLOOR EL. ±45'-9"				
				
EL. ±35'-10"				
- ROOF EL. ±31'-10"				
2ND FLOOR EL. ±16'-0"				
STREETLEVEL				
			ST ELEVATION	
	DM-203	SC.	ALE: 1/8" = 1'-0"	
DEMOLITION KEY NOTES				
D1 EXISTING EXTERIOR MASONRY WALLS T D2 EXISTING INTERIOR METAL FRAMED PAI		D13	REMOVE EXISTING HVAC SYSTEM INCLUDING AIR DIFFUSERS, THERMOSTATS, AND ALL ASSOCIATED DUCTWORK, CONDUITS AND WIRING THROUGHOUT.	
D3 EXISTING CONCRETE SLAB TO BE REMO	OVED, TYP.	014	EXISTING FIRE PROTECTION SYSTEM INCLUDING SPRINKLERS, FIRE HOSE, AND ALL ASSOCIATED PIPING, RISER, VALVES, AND PUMPS TO BE REMOVED.	
D4 REMOVE ALL INTERIOR FINISHES INCLU PORCELAIN TILE), WALL BASE, WALL CO	OVERING, ETC.		REMOVED. REMOVE EXISTING SUSPENDED CEILING SYSTEM WITH ALL ASSOCIATED COMPONENTS THROUGHOUT.	
D5 EXISTING WINDOWS AND WINDOW COVI THROUGHOUT. D6 EXISTING H.M. DOORS AND FRAMES TO			EXISTING ELEVATOR SYSTEM, HOISTWAY STRUCTURE, ALL ASSOCIATED ACCESSORIES INCLUDING CONTROL PANELS	
D7 REMOVE ALL MILLWORK AND BUILT-IN F INCLUDING BENCHES, COUNTERS, CABI	URNISHINGS THROUGHOUT,		AND ELECTRICAL SYSTEM TO BE REMOVED. EXISTING FIRE ALARM SYSTEM, INCLUDING PANELS, STROBES, HORNS, AND ALL ASSOCIATED CONDUITS AND	
D8 EXISTING KITCHEN PANTRY COUNTER A	JRES INCLUDING TOILETS, SINKS,		REMOVE EXISTING VEHICLE LIFTS AND REPAIR EQUIPMENT.	
D9 BATHTUBS, AND ALL ASSOCIATED PLUM	IBING PIPING/DRAINAGE LINES.			
CUT AND CAP PLUMBING LINES AT THE		D19	REMOVE EXISTING STAIRS AND RAILINGS THROUGHOUT,	
	EMOVED UIPMENT AND FIXTURES		REMOVE EXISTING STAIRS AND RAILINGS THROUGHOUT, TYP. REMOVE ELEVATOR AND STAIR BULKHEAD.	

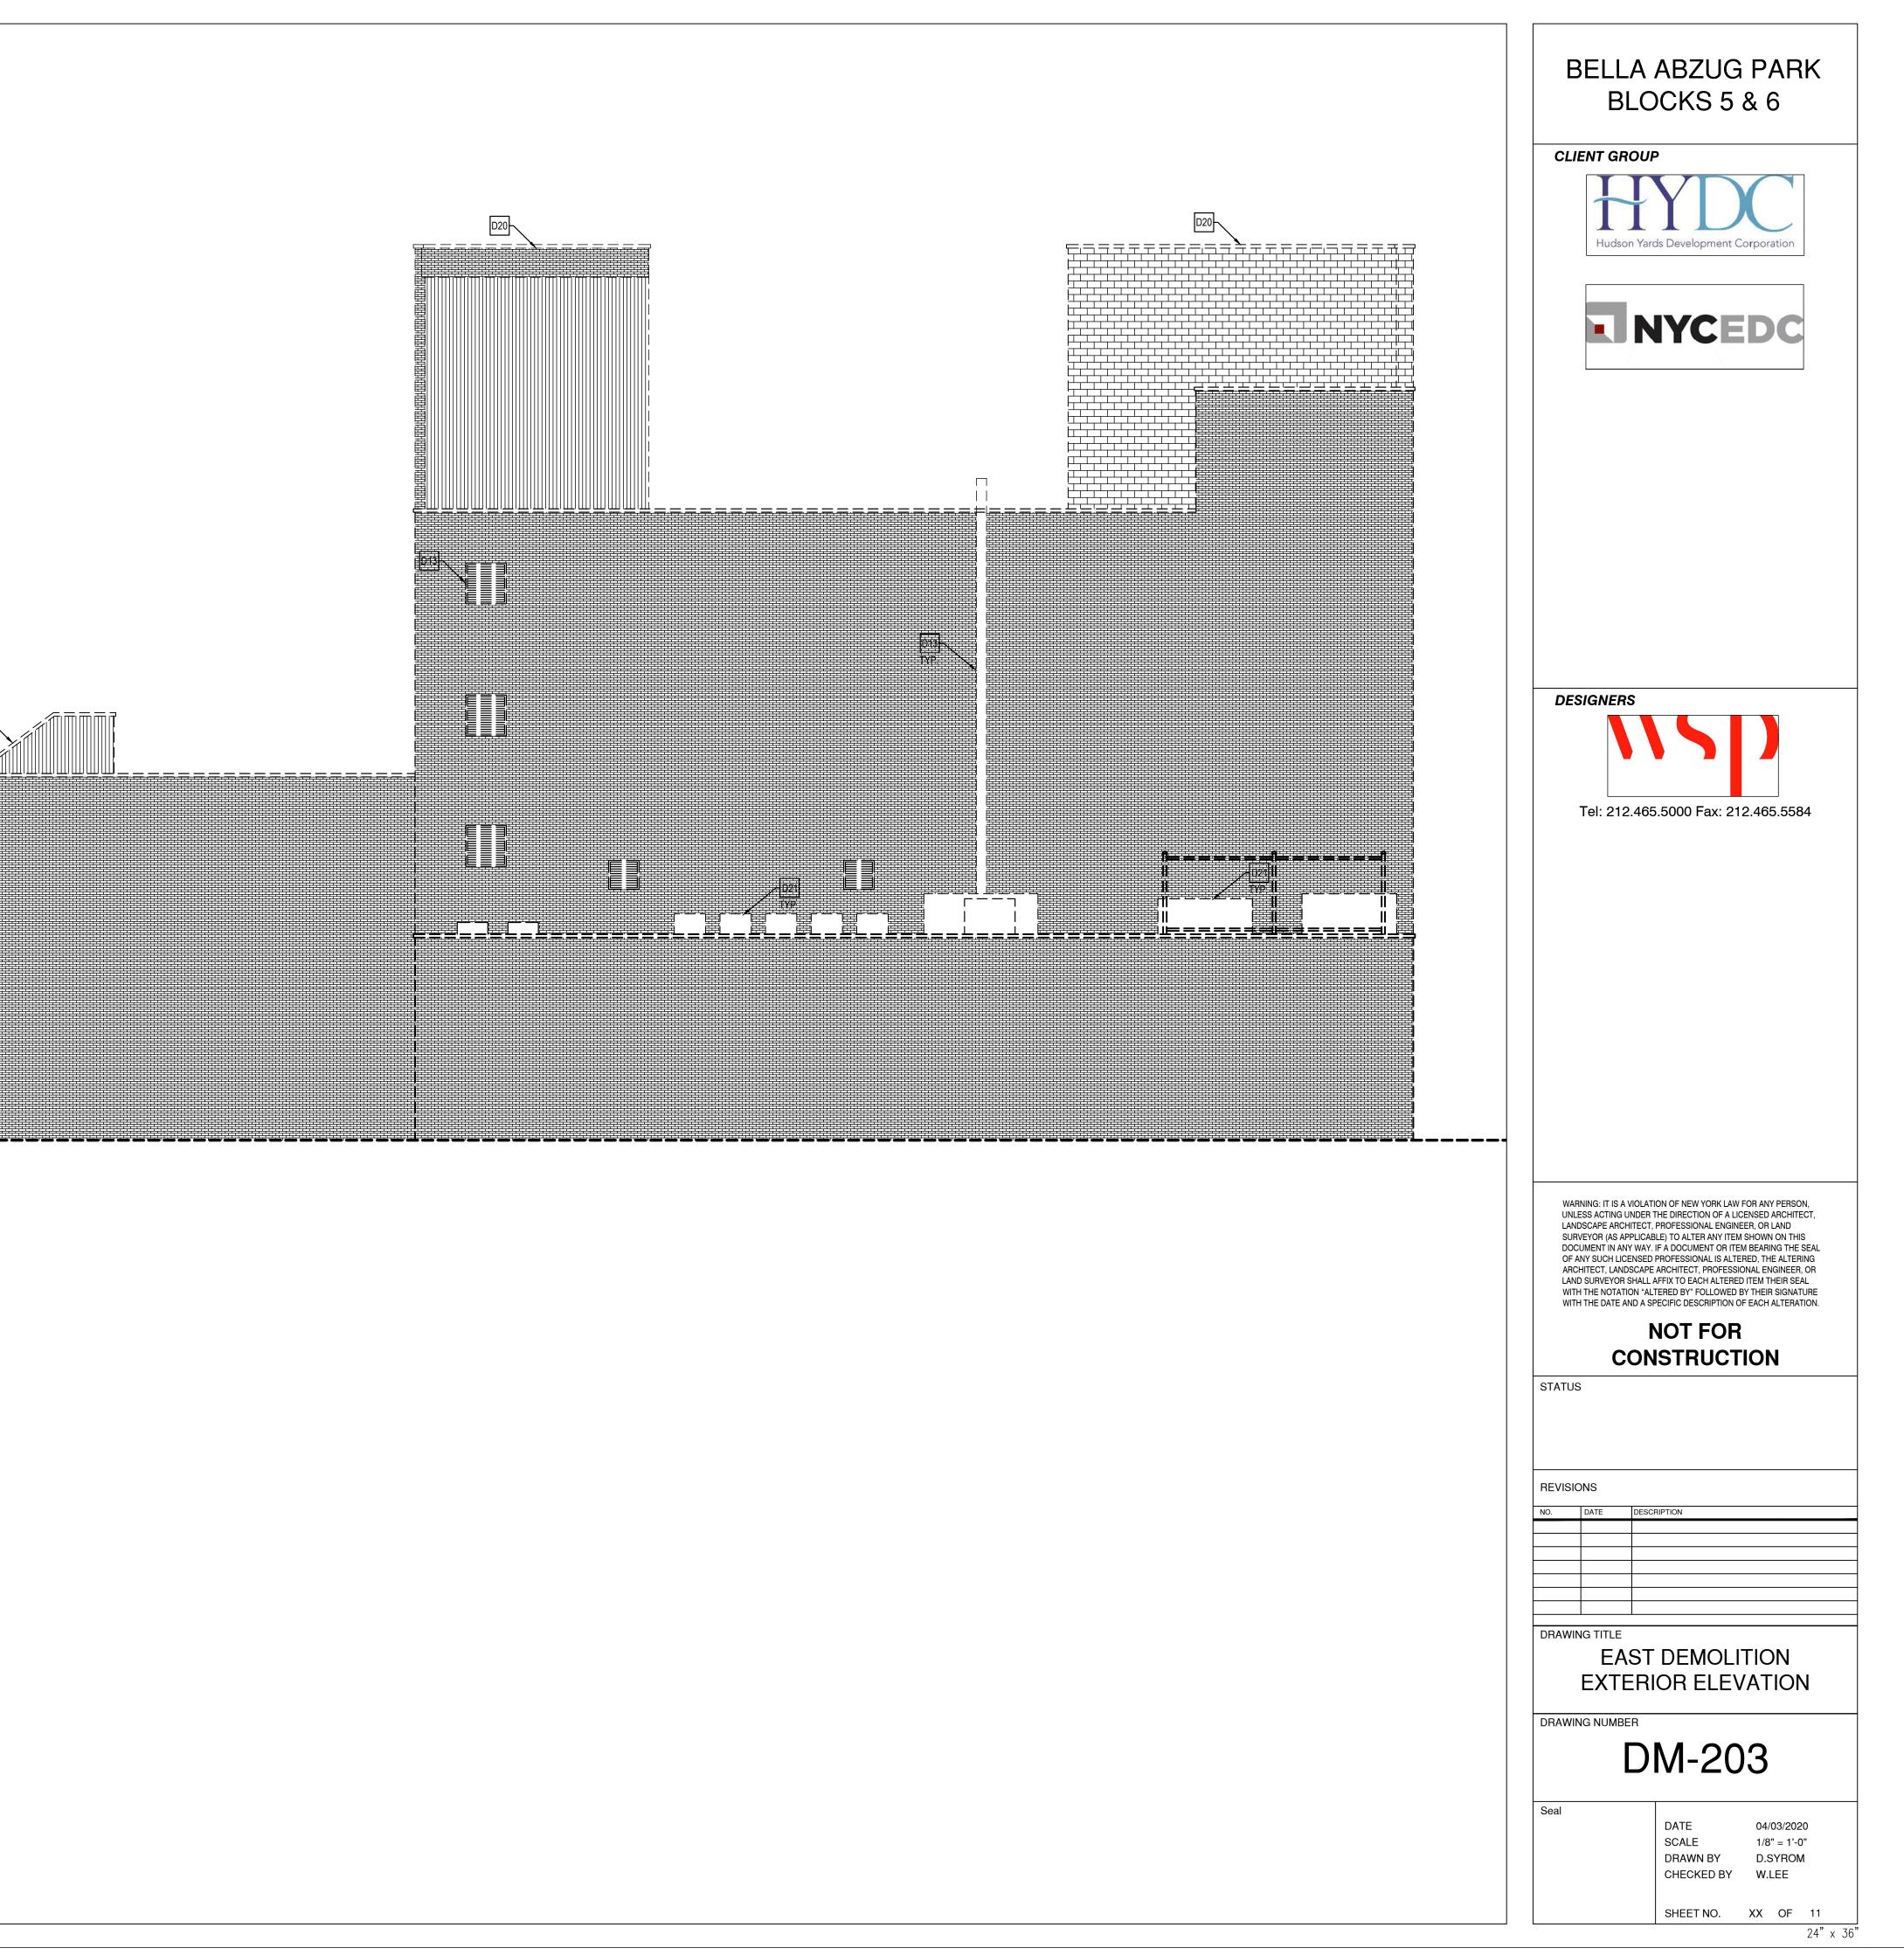

			<u> </u>				
BULKHEAD ROOF EL. ±82'-10"							
						D13	
♥ EL.±62'-2"							
EL. ±58'-2"							
4THFLOOR EL. ±45'-9"							
TOP OF PARAPET EL. ±35'-10"							
Ψ EL. ±31'-10"							
EL.±16'-0"							
EL. ±0'-0"			, , _ , _ , _ ,				
			EVATION				
	DM-204	SCALE: 1	/8" = 1'-0"				
DEMOLITION KEY NOTES							
D1 EXISTING EXTERIOR MASONRY WALLS		D13 THERMO	EXISTING HVAC S STATS, AND ALL AS				
	ARTITIONS TO BE REMOVED.	D13 THERMO WIRING D14 EXISTING AND ALL	DSTATS, AND ALL AS THROUGHOUT. 3 FIRE PROTECTION ASSOCIATED PIPIN	SSOCIATED DUCTV	NORK, CONDUIT	"S AND S, FIRE HOSE,	
D1EXISTING EXTERIOR MASONRY WALLSD2EXISTING INTERIOR METAL FRAMED PD3EXISTING CONCRETE SLAB TO BE REMD4REMOVE ALL INTERIOR FINISHES INCL PORCELAIN TILE), WALL BASE, WALL C	ARTITIONS TO BE REMOVED. MOVED, TYP. .UDING FLOORING (CARPET, VCT & COVERING, ETC.	D13 THERMO WIRING D14 EXISTING AND ALL REMOVE	DSTATS, AND ALL AS THROUGHOUT. G FIRE PROTECTION ASSOCIATED PIPIN D. /E EXISTING SUS	SSOCIATED DUCTV N SYSTEM INCLUD IG, RISER, VALVES SPENDED CEILI	VORK, CONDUIT ING SPRINKLER 3, AND PUMPS TO	"S AND S, FIRE HOSE, O BE	
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